



City Of

Public Improvement Standards

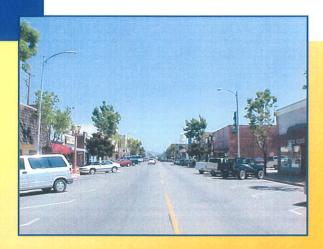

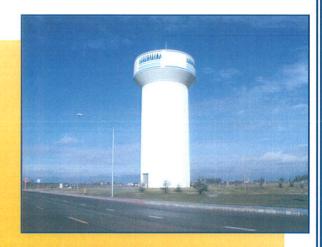

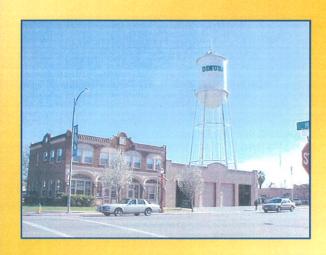

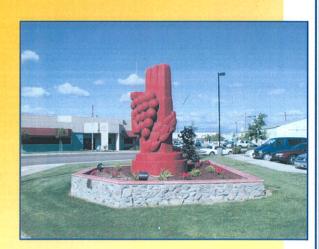

CITY OF DINUBA PUBLIC IMPROVEMENT STANDARDS

SECTION 1 - SANITARY SEWER

<u>Drawing No</u>	<u>Title</u>
SS-1	SEWER AND WATER SERVICE PROPERTY LOCATIONS
SS-1a	SEWER AND WATER SERVICE PROPERTY LOCATIONS WITH PARK STRIPS SHOWN
SS-2	INVERT PLANS OF STANDARD MANHOLES
SS-3	STANDARD MANHOLE
SS-4	STANDARD DROP MANHOLE
SS-5	SEWER LATERALS
SS-6	MANHOLE FRAME AND COVER
SS-7	SEWER LAMPHOLE

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<u>Title</u>
ABANDONMENT OF EXISTING WELL
WATER BLOW-OFF
THRUST BLOCK DETAILS
BACKFLOW DEVICE AND FIRE DEPARTMENT CONNECTION
STANDARD FIRE HYDRANT
STANDARD FIRE HYDRANT WITH PARK STRIPS SHOWN
TYPICAL FIRE HYDRANT LOCATION PAVEMENT MARKERS
VALVE WELL AND COVER
1" RESIDENTIAL WATER SERVICE
1" RESIDENTIAL WATER SERVICE WITH PARK STRIPS SHOWN
1 1/2" AND 2" COMMERCIAL WATER SERVICE
1 1/2" AND 2" COMMERCIAL WATER SERVICE WITH PARK STRIPS SHOWN
3/4" TO 2" REDUCED PRESSURE PRINCIPAL BACKFLOW PREVENTERS
PIPE TRENCH DETAIL
WATER SAMPLE STATION DETAIL "A" (PAGE 10F 2)
WATER SAMPLE STATION DETAIL "A" WITH PARK STRIP (PAGE 10F 2)
WATER SAMPLE STATION DETAIL "B" (PAGE 2 OF 2)
WATER SAMPLE STATION DETAIL "B" WITH PARK STRIPS (PATE 2 OF 2)
PRESSURE VACUUM BREAKER BACKFLOW PREVENTER INSTALLATION
COMPOUND OR TURBINE METER SETTING WITH REDUCED PRESSURE DEVICE
DOUBLE CHECK VALVE INSTALLATION
APPROVED PORTABLE WATER TRANSPORT BACKFLOW PROTECTION
TYPICAL INTERSECTION CONNECTIONS
LOCATIONS OF UTILITY MAINS
LOCATIONS OF UTILITY MAINS WITH PARK STRIPS

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SD-2	TYPE "B" CATCH BASIN 48" CURB INLET & 48"X36" BASIN
SD-3	TYPE "C" CATCH BASIN 24" DIA. INLET DRAIN PIPE

SD-4	TYPE "D" CATCH BASIN STANDARD FLAT GRATE
SD-5	STORM DRAIN MANHOLE
SD-6	CATCH BASIN GRATES
SD-7	"CHRISTY" U SERIES CATCH BASINS
SD-8	TOP EDGE CHOICES FOR CATCH BASIN AND OR GRATE RING
SD-9a	TYPE "E" CATCH BASIN 7FT, CURB INLET
SD-9b	MANHOLE FRAME AND COVER FOR TYPE "E" INLET
SD-9c	DETAIL OF TYPE "E" INLET OPENING
SD-10	TYPE "G" INLET (PAGE 1 OF 2)
SD-10a	TYPE "G" INLET (PAGE 2 OF 2)
SD-10b	MANHOLE FRAME AND COVER FOR TYPE "G" INLET
SD-10c	DETAIL OF TYPE "G" INLET OPENING

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<u>Drawing No</u>	<u>Title</u>
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C-1a	VALLEY GUTTER WITH PARK STRIPS SHOWN
C-2	STANDARD 30" CURB & GUTTER
C-3	CURB, GUTTER & SIDEWALK
C-3a	CURB, GUTTER & SIDEWALK WITH PARK STRIPS
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C-5	BARRIER TYPE LANDSCAPE CURB
C-6	DECROATIVE CURB, GUTTER AND SIDEWALK
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C-10a	COMMERCIAL & INDUSTRIAL DRIVEWAY
C-11	TYPICAL DRIVEWAY LOCATION DETAIL ALTERNATE #1
C-11a	TYPICAL DRIVEWAY LOCATION DETAIL ALTERNATE #1 WITH PARK STRIPS


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Drawing No	<u>Title</u>
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P-1a	PARKING LOT REQUIREMENTS WITH PARK STRIPS SHOWN
P-2	PARKING LOT DRAINAGE DETAILS
P-3	COMMERCIAL & RESIDENTIAL ALLEYS
P-3a	COMMERCIAL & RESIDENTIAL ALLEYS WITH PARK STRIPS
P-4	DRIVEWAY APPROACH DETAILS
P-4a	DRIVEWAY APPROACH DETAILS WITH PARK STRIPS
P-5	ARTERIAL STREET (100' R.O.W.)
P-5a	ARTERIAL STREET (104' R.O.W.) WITH PARK STRIPS
P-6	ARTERIAL STREET (96' R.O.W.)
P-6a	ARTERIAL STREET (96' R.O.W.) WITH PARK STRIPS
P-7	MAJOR COLLECTOR STREET (84' R.O.W.)
P-7a	MAJOR COLLECTOR STREET (94' R.O.W.) WITH PARK STRIPS
P-8	MINOR COLLECTOR STREET (72' R.O.W.)

	<u> </u>	
	⁻⁸ a	MINOR COLLECTOR STREET (80' R.O.W.) WITH PARK STRIPS
F	P-9	LOCAL COLLECTOR STREET (60' R.O.W.)
F	P-9a	LOCAL COLLECTOR STREET (60' R.O.W.) WITH PARK STRIPS
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F	P-10a	LOCAL STREET (60' R.O.W.) WITH PARK STRIPS
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P	P-13a	MAJOR ARTERIAL WITH MEDIAN WITH PARK STRIPS
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Р	⁾ -14a	COLLECTOR WITH MEDIAN WITH PARK STRIPS
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Р	⁹ -15a	STREET SUMMARY SHEET WITH PARK STRIPS
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	2-17	STREET BULB CONNECTION
Р	P-18	STANDARD CROSSWALK MARKINGS
Р	'-18a	STANDARD STOP BAR & STOP SIGN LOCATION MARKINGS WITH PARK STRIPS
Р	-18b	STANDARD STOP BAR AND STOP SIGN LOCATION MARKER
Р	'-18c	STANDARD STOP BAR AND STOP SIGN LOCATION MARKER WITH PARK STRIPS
Р	-19	STREET SIGN STANDARD (PAGE 1 OF 2)
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P	-20	STREET SIGN STANDARD (PAGE 2 OF 2)
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þ.	-22	TIMBER BARRICADE

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E-2	PROTECTION POST
E-3	TRASH BIN-STUCCO ENCLOSURE
E-4	TRASH BIN-BLOCK ENCLOSURE
E-4a	REFUSE CONTAINER ENCLOSURE STEEL SWING GATES
E-5	FENCE DETAIL
E-6	ELEVATION BENCHMARK DETAILS
E-7	PROPERTY MONUMENT DETAILS
E-8	TYPICAL PARKING LOT DESIGN & LANDSCAPE
E-9	HANDICAPPED PARKING
E-10	MASONRY BLOCK WALL/FENCE
E-11	"ANAHEIM" STREET & AREA LIGHT POLE BASE DETAIL
E-12	SPECIAL CONST. REQUIREMENTS FOR SEWER & WATER SEPARATION
E-13	PIPE SUPPORTS ACROSS TRENCHES
E-14	GATED ENTRY FOR PRIVATE STREETS
E-15	TYPICAL LOT DRAINAGE
E-15a	TYPICAL LOT DRAINAGE WITH PARK STRIPS SHOWN
E-16	MONUMENT SIGN




STREET

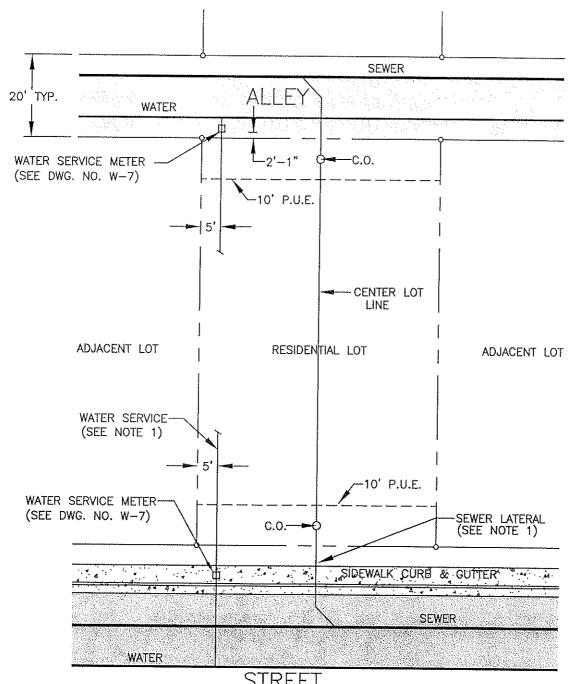NOTES:

- SEWER LATERAL TO BE LOCATED 5' FROM CENTER LOT LINE; WATER LATERAL TO BE LOCATED 5' 1. FROM PROPERTY LINE.
- SEWER LATERAL 5 ' ON PROPERTY WITH CLEANOUT ON BOTH STREET AND ALLEY SIDE. SEE SS-4. ALL UTILITIES AND DRIVEWAYS SHALL BE LOCATED AT OPPOSITE PROPERTY LINE FROM WATER 3. METER LOCATION.
- FOR WATER METER INSTALLATION, SEE W-7. 4.
- TWO WAY CLEANOUT AT BUILDING TO REPLACE CLEANOUT IN P.U.E.

CITY COUNCIL APPROVAL: 2-27-0 SEWER AND WATER SERVICE DRAWING NO. PROPERTY LOCATIONS FILE NAME: SS-1.dwg Dwn: Lubong REVISIONS BY DATE CITY OF DINUBA Gen Notes T.S. 4/14/06 Public Improvement Standards APPROVED BY PUBLIC WORKS DIRECTOR

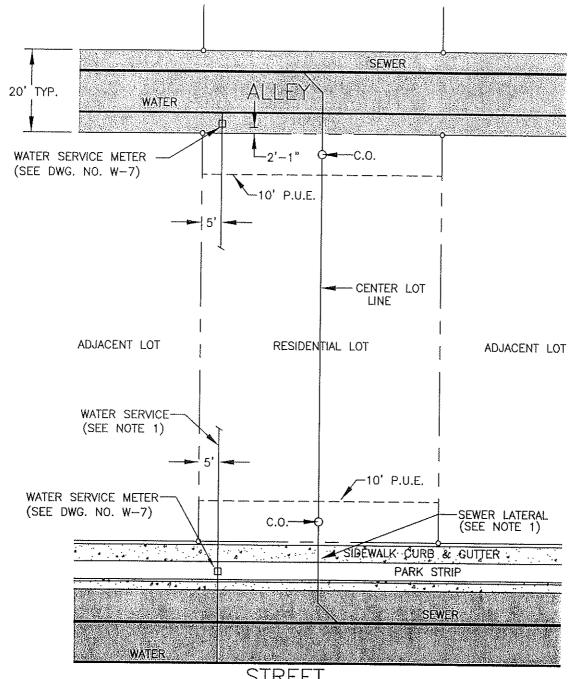


STREET

NOTES:

- SEWER LATERAL TO BE LOCATED 5' FROM CENTER LOT LINE; WATER LATERAL TO BE LOCATED 5' FROM PROPERTY LINE.
- SEWER LATERAL 5 ' ON PROPERTY WITH CLEANOUT ON BOTH STREET AND ALLEY SIDE. SEE SS-4.
- ALL UTILITIES AND DRIVEWAYS SHALL BE LOCATED AT OPPOSITE PROPERTY LINE FROM WATER 3. METER LOCATION.
- FOR WATER METER INSTALLATION, SEE W-7. 4.
- 5. TWO WAY CLEANOUT AT BUILDING TO REPLACE CLEANOUT IN P.U.E.
- REFER TO 2007 GENERAL PLAN UPDATE.


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- PIPE (C-900 OR SDR-35) THROUGH MANHOLE REQUIRES AN APPROVED WATER STOP.
- TERMINATING PIPES TO EXTEND INTO MANHOLE A MAX. 1".
- THE TOP HALF OF ALL PIPE WITHIN THE MANHOLE IS TO BE CUT AWAY. 3.
- PREPARE A SMOOTH TROWELED CONCRETE CHANNEL HAVING UNIFORM GRADIENT BETWEEN PIPE INVERTS.
- 5. EXTEND THE CHANNEL WALLS UP TO SAME HEIGHT WITH TOP OF THE PIPE.
- HAND TAMP 9" OF SAND OR APPROVED BACKFILL MATIERIAL UNDER ALL PIPING COMING IN OR OUT OF THE 6.
- MANHOLE UP TO THE FIRST JOINT.
 THE BREADTH OF THE CHANNEL AT EACH JUNCTION MUST ALWAYS BE AS GREAT AS THE CHANNEL RADIUS OF THE CONNECTED PIPE.
- 8. SLOPE THE BENCHING UP TOWARDS THE MANHOLE WALL AS INDICATED IN THE MANHOLE SECTION. TROWEL THE
- ON A STANDARD MANHOLE, INCOMING NON-STRAIGHT LINES SHALL HAVE AN INVERT THAT IS AT LEAST 1" HIGHER THAN THE OUT-GOING LINE, UNLESS OTHERWISE APPROVED.
- 10.
- MAXIMUM OF 3 INLET PIPES INTO MANHOLE.

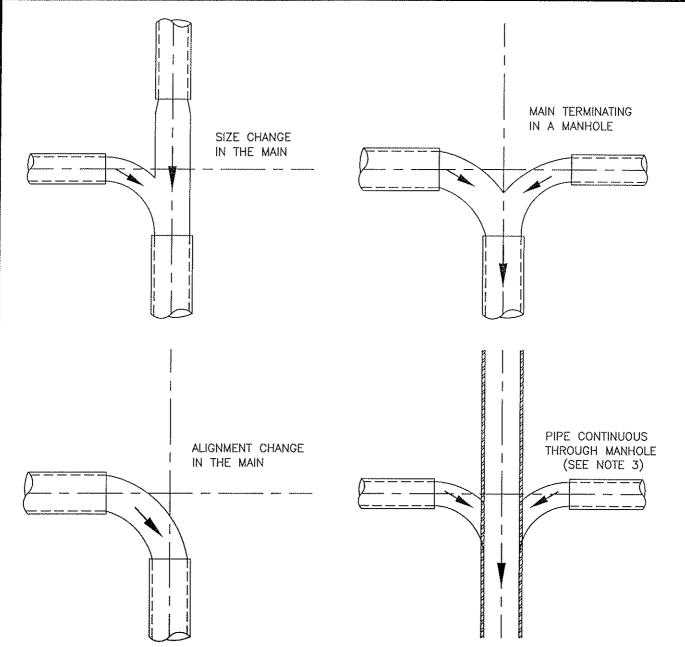
 MAXIMUM OF 2 SANITAR SEWER LATERALS CAN BE CONNECTED TO A MANHOLE.

ť	CITY COUNCIL APPROVAL: 2-27-07	INVERT PLANS OF STANDARD	DRAWING NO. SS-2		
Ŀ	APPROVED BY CITY ENGINEER	MANHOLES	FILE NAME: SS-2.dwg REVISIONS	Dwn: BY	Vasquez DATE
	SAMUA OLITALA APPROVED BY PUBLIC WORKS DIRECTOR	CITY OF DINUBA Public Improvement Standards	Border		4/14/06



- ALL CONCRETE SHALL BE CLASS "A" (6 SACK MIN.), TYPE V CEMENT. 1.
- 2. CONCRETE CONE AND GRADE RINGS SHALL BE PRECAST REINFORCED AS PER ASTM C-478.
- GROUT AND BAND ALL PIPE JOINTS. "KENT" SEAL NO. 2 OR APPROVED EQUAL. GROUT MIXTURE SHALL BE 1:2 CEMENT TO SAND. 3.
- 4.
- WHERE MANHOLES ARE NOT IN STREETS OR TRAVEL WAYS, PLACE TOP 12"-24" ABOVE EXISTING GROUND WITH A 24" CONCRETE COLLAR, UNLESS OTHERWISE SHOWN ON THE PLANS. FOR MAJOR ARTERIALS, BASE SHALL BE CLASS "A" (6 SACK MIX WITH 3/4" AGGREGATE). IF LARGEST PIPE SIZE IS 24" OR LARGER, A 60" MIN. DIAMETER MANHOLE IS REQUIRED. WHEN ADJUSTING A MANHOLE, REFER TO STANDARD DRAWING NO. SS-6.
- 7.
- 8.
- SEWER LATS. SHALL ENTER MANHOLE 1" ABOVE MAIN. HOLE FOR LATS. SHALL BE BORED OR OTHER APPROVED METHOD.
- 10. NO FLOODING OR JETTING COMPACTION.
- MAXIMUM DISTANCE BETWEEN MANHOLES SHALL BE 400'±.
- SEWER LATERALS 6" AND LARGER CONNECTIONS TO A MAIN REQUIRES A SANITARY SEWER MANHOLE.

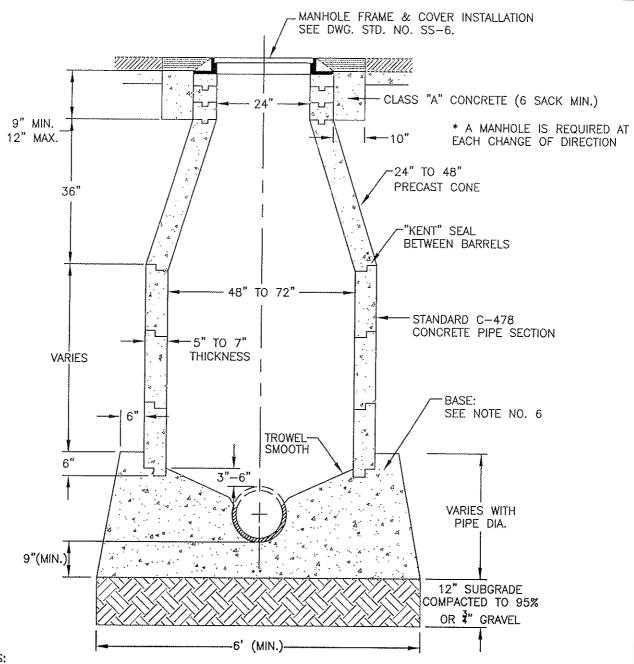
CITY COUNCIL APPROVAL: DRAWING NO. STANDARD MANHOLE FILE NAME: SS-3.dwg Dwn: Vasquez REVISIONS BY DATE CITY OF DINUBA Gen Notes, Dims T.S. 4/14/06 Public Improvement Standards

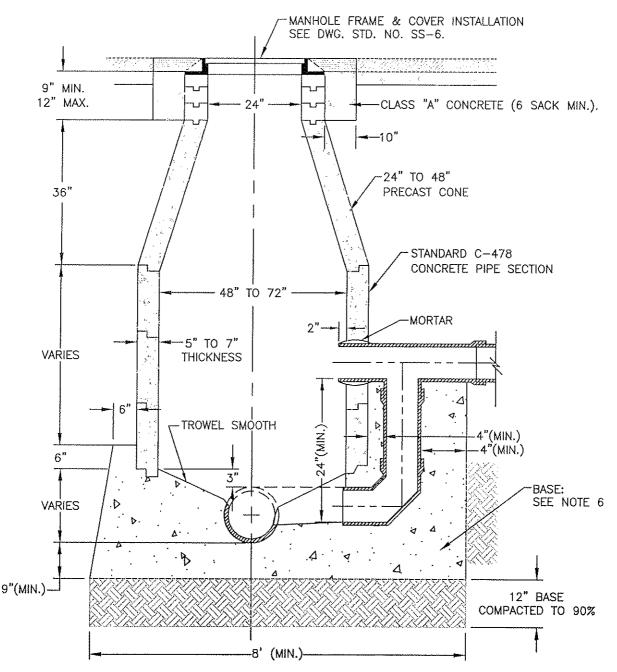



- ALL CONCRETE SHALL BE CLASS "A" (6 SACK MIN), TYPE V CEMENT.
- CONCRETE CONE AND GRADE RINGS SHALL BE PRÉCAST REINFORCED AS PER ASTM C-478.
- GROUT AND BAND ALL PIPE JOINTS OR KENT SEAL NO.2 OR APPROVED EQUAL. GROUT MIXTURE SHALL BE 1:2 CEMENT TO SAND.
- WHERE MANHOLES ARE NOT IN STREETS OR TRAVEL WAYS, PLACE TOP 12"-24" ABOVE EXISTING GROUND WITH 24" CONCRETE COLLAR, UNLESS OTHERWISE SHOWN ON THE PLANS. FOR MAJOR ARTERIALS, BASE SHALL BE CLASS "A" (6 SACK MIX WITH 3/8" AGGREGATE). IF LARGEST PIPE SIZE IS 24" OR LARGER, A 60" DIAMETER MANHOLE IS REQUIRED. WHEN ADJUSTING A MANHOLE, REFER TO CITY STANDARD SS-6.

- 8.
- NO FLOODING OR JETTING COMPACTION.
- MAXIMUM DISTANCE BETWEEN MANHOLES SHALL BE 400'±.
- SEWER LATERALS 6" AND LARGER CONNECTED TO A MAIN REQUIRES A SANITARY SEWER MANHOLE.

CITY COUNCIL APPROVAL: 2-27-0 DRAWING NO. STANDARD DROP MANHOLE FILE NAME: SS-4.dwg Dwn: Vasque: BY DATE CITY OF DINUBA Gen Notes T.S. 4/14/06 Public Improvement Standards

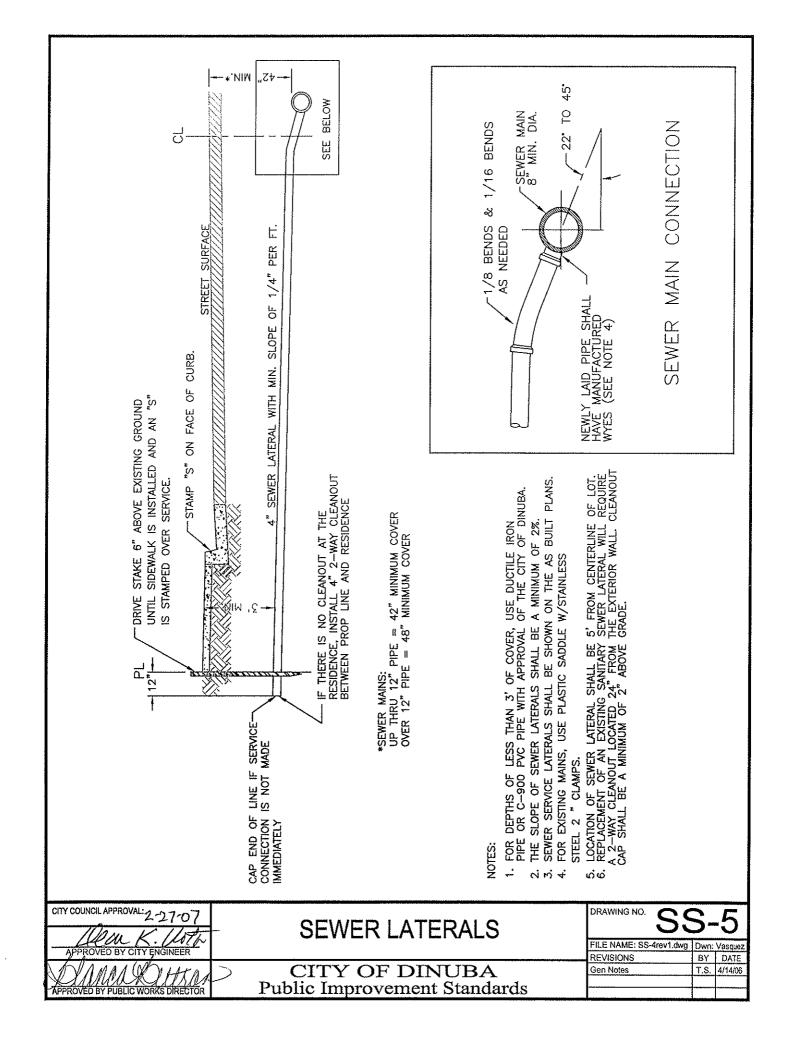

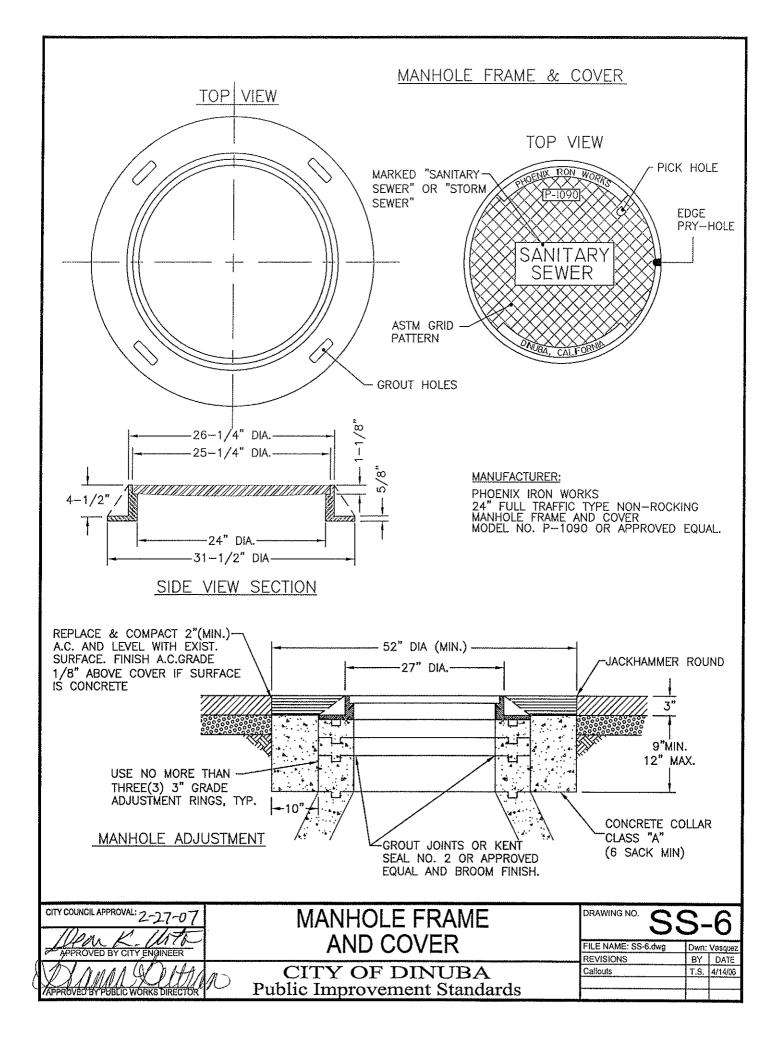

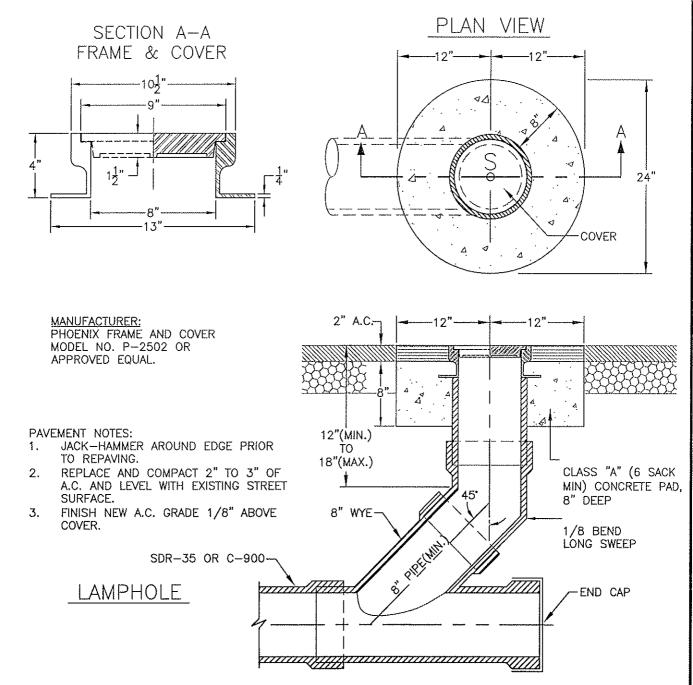


LAMPHOLE NOTES:

1. PIPE AND FITTINGS, EXCEPT AS OTHERWISE SHOWN HEREON, SHALL BE OF THE SAME MATERIAL AS THE SEWER, UNLESS APPROVED ADAPTORS ARE UTILIZED.

2. PIPES AND FITTINGS SHALL BE PROPERLY ALLIGNED AND MAINTAINED WHILE CONCRETE IS BEING PLACED AND ALLOWED TO HARDEN, JOINTS FOR PIPES AND FITTINGS SHALL BE MADE PRIOR TO PLACING CONCRETE. CONCRETE FOR BEDDING, ENCASEMENT, AND WALL SUPPORT FOR PIPES AND FITTINGS SHALL BE PLACED UNIFORMLY AROUND THE PIPE AND FITTINGS, AND SHALL BE CLASS "A".


3. THE ACCESS FRAME, COVER AND CAP SHALL BE CAST IRON. 4. CLEANOUT INSTALLED BEHIND AN END STREET BARRICADE SHALL HAVE A 2'X2'X8" CONCRETE PAD PLACED AROUND IT.

SEWER LAMPHOLE	DRAWING NO. S	DRAWING NO. SS-7		
	FILE NAME: SS-7.dwg REVISIONS	Dwn: Vasquez BY DATE		
CITY OF DINUBA Public Improvement Standards	Gen Notes, Dims	T.S. 4/14/06		
	CITY OF DINUBA	SEWER LAMPHOLE FILE NAME: SS-7.dwg REVISIONS		

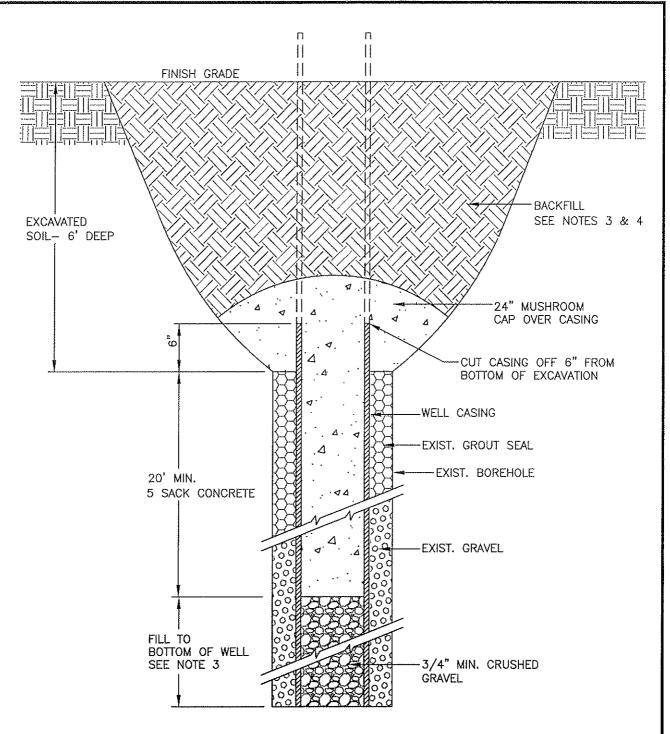


- 1. IMPERVIOUS MATERIALS INCLUDE NEAT CEMENT, SAND-CEMENT GROUT, CONCRETE AND HIGH-SOLIDS BENTONITE.
- 2. FILL INCLUDES CLASS "B" CONCRETE (5 SACK MIN.) OR SLURRY ONLY.
- 3. ORGANIC MATERIALS SHALL NOT BE USED.
- 4. A PERMIT SHALL BE OBTAINED FROM CITY OR COUNTY, AND A WELL LOG SHALL BE PROVIDED.
- 5. A CITY INSPECTOR SHALL BE ON SITE DURING WELL ABANDONMENT.
- 6. ALL WORK MUST COMPLY WITH TULARE COUNTY ENVIRONMENTAL HEALTH REQUIREMENTS.

	CITY COUNCIL APPROVAL: 2-27-07	ABANDONMENT OF	DRAWING NO.	/-	1
	APPROVED BY CITY ENGINEER	EXISTING WELL	FILE NAME: W-1rev1.dwg REVISIONS	Dwn; BY	Vasquez DATE
$\left(\right)$	APPROVED BY PUBLIC WORKS DIRECTOR	CITY OF DINUBA Public Improvement Standards	Gen Notes, Dims	T.S.	4/14/06

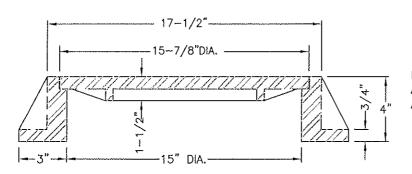


MANUFACTURER: "PHOENIX" FRAME AND COVER MODEL NO. P-7001 OR APPROVED EQUAL

FRAME & COVER-SIDE VIEW SECTION

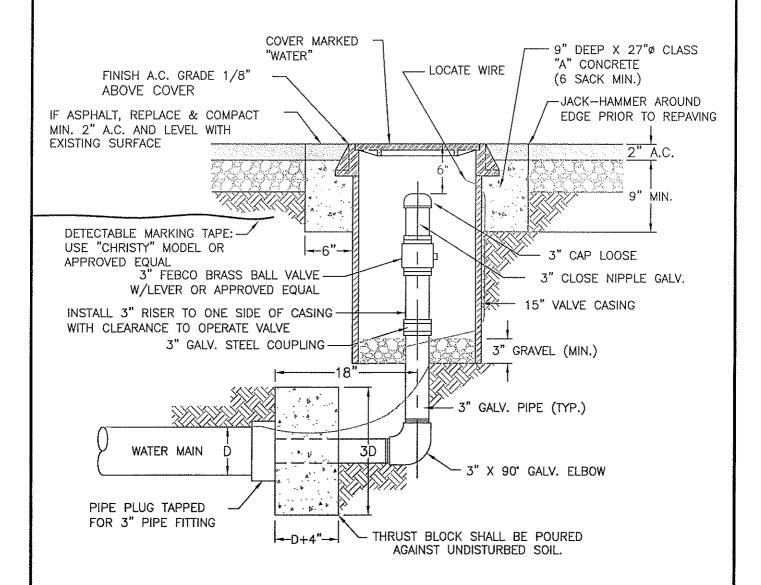

CITY COUNCIL APPROVAL: 2-27-07	WATER BLOW-OFF	DRAWING NO.	W	- 2	2
APPROVED BY CITY ENGINEER	!	FILE NAME: W-2n		Dwn: \ BY	Vasquez DATE
APPROVED BY PUBLIC WORKS DIRECTOR	CITY OF DINUBA Public Improvement Standards	Gen Notes			4/14/06

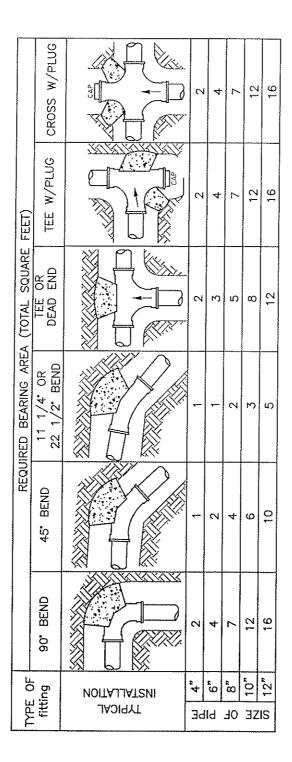

THRUST BLOCKS SHALL BE USED FOR PIPES WITH 4" DIAMETER OR LARGER.

THRUST BLOCKS TO BE CONSTRUCTED OF CLASS "B" CONCRETE vi

(5 SACK

MINIMUM THICKNESS OF THRUST BLOCKS TO BE 6 INCHES.
THRUST BLOCKS TO BE POURED AGAINST UNDISTURBED SOIL.
AREAS GIVEN ARE FOR CLASS 150 PIPE AT PRESSURE OF 150 P.S.I IN
SOIL WITH 2,000 P.S.F. CAPACITY. INSTALLATION USING DIFFERENT PIPE, w. 4; €.

ACCORDINGLY, SUBJECT TO APPROVAL OF CITY ENGINEER.
THRUST BLOCKS SHALL BE POURED A MIN. OF 5 DAYS BEFORE PRESSURE, AND/OR SOIL TYPES SHOULD ADJUST AREAS

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MEG-A-LUG JOINTS MAY BE USED IN LIEU OF THRUST BLOCKS UPON APPROVAL BY THE DEVELOPMENT SERVICES DEPARTMENT. PRESSURIZING THE SYSTEM.


CITY COUNCIL APPROVAL 2-27-0

THRUST BLOCK DETAILS

CITY OF DINUBA Public Improvement Standards

DRAWING NO.


FILE NAME: W-3rev1.dwg Dwn: Vasquez REVISIONS BY DATE T.S. 4/14/06

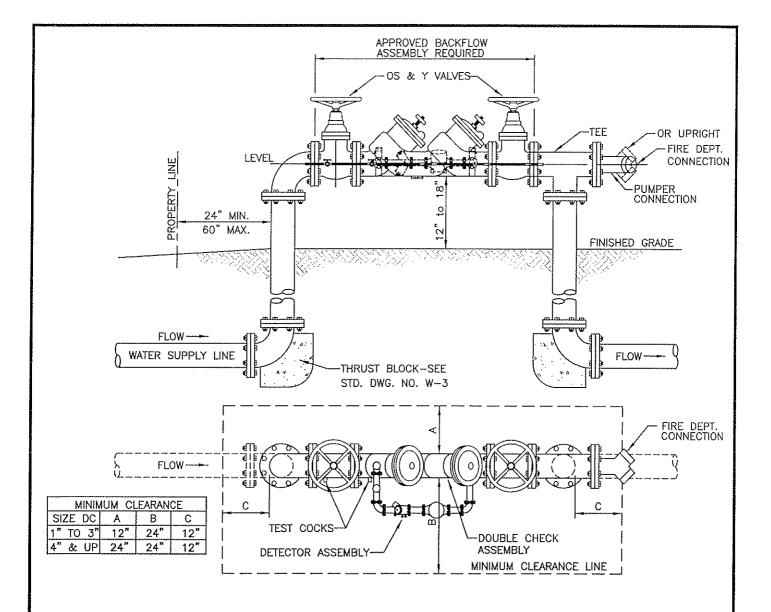

GENERAL NOTES:

- RESILIENT SEATED SHUT OFF VALVES AND TEST COCKS ARE REQUIRED
- NO TAPS. TEES OR CONNECTIONS OF ANY KIND ARE PERMITTED BETWEEN THE WATER METER AND THE BACKFLOW ASSEMBLY.
- PROTECTION FROM FREEZE DAMAGE IS REQUIRED IN EXPOSED AREAS.
- ASSEMBLY MUST BE ACCESSIBLE FOR TESTING AND MAINTENANCE PER CITY OF DINUBA PUBLIC WORKS DEPARTMENT.
- 5.
- ASSEMBLY TO BE THE SAME SIZE AS THE WATER SUPPLY LINE PER UNIFORM PLUMBING CODE. PRESSURE LOSS THROUGH ASSEMBLY MUST BE INCLUDED IN PRESSURE LOSS CALCULATIONS FOR SIZING OF THE WATER SYSTEM PER UNIFORM FIRE CODE.
- MINIMUM CLEARANCES AROUND ASSEMBLY MUST BE MAINTAINED. REFER TO MINIMUM CLEARANCE CHART ON THIS PAGE.
- 8. ANY DEVIATION FROM THESE REQUIREMENTS SHALL BE APPROVED BY THE WATER SYSTEM MANAGER OR CROSS CONNECTION CONTROL SPECIALIST PRIOR TO INSTALLATION.
- THE BACKFLOW PREVENTER DEVICES AND INSTALLATIONS SHALL BE APPROVED BY THE CITY OF DINUBA PUBLIC WORKS DEPARTMENT.
- BACKFLOW ASSEMBLY SHALL BE INSPECTED AND TESTED BY THE PUBLIC WORKS DEPARTMENT OR PROVIDE A CERTIFICATE SHOWING THE ASSEMBLY WAS TESTED AND PASSED.
- IF VALVES ARE RESILIANT SEAT TYPE A POST INDICATOR IS REQUIRED. 11.
- A CITY STANDARD FIRE HYDRANT MUST BE WITHIN 25' OF FIRE DEPARTMENT CONNECTION OR INSTALLED WITHIN 25' OF THE FIRE DEPARTMENT CONNECTION.
- LOCATION OF THE ASSEMBLY MUST BE APPROVED BY THE ASSISTANT FIRE CHIEF/FIRE MARSHALL,




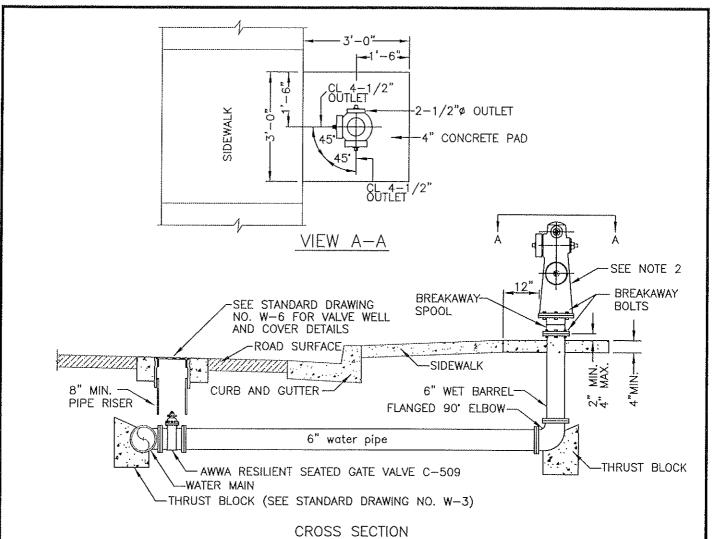

CNOSS SECT

- TRADE NAMES ARE SPECIFIED AS A STANDARD OF ACCEPTABLE QUALITY AND FEATURES. EQUIPMENT OF EQUAL QUALITY WITH EQUAL FEATURES MAY BE SUBSTITUTED ONLY WITH WRITTEN APPROVA FROM THE DINUBA FIRE DEPTARTMENT.
- 2. HYDRANTS SHALL BE "CLOW" MODEL 865, WET BARREL, OR APPROVED EQUAL.
- 3. HYDRANTS SHALL HAVE (2)-4 1/2" DIAMETER OUTLETS AND (1)-2 1/2" DIAMETER OUTLET.
- 4. NOZZLE CENTERLINES SHALL BE LOCATED NOT LESS THAN 18" ABOVE FINISH GRADE.
- 5. GATE VALVES SHALL BE "RESILIENT SEAT" TYPE FLANGED TO MAIN LINE.
- HYDRANT SHALL BE EQUIPPED WITH A "BREAKAWAY" TYPE SPOOL AND "BREAKAWAY" BOLTS BETWEEN HYDRANT AND RISER.
- A BLUE TWO-WAY REFLECTIVE MARKER SHALL BE INSTALLED ON THE CENTERLINE OF THE STREET ADJACENT TO THE HYDRANT.
- 8. HYDRANTS SHALL HAVE A 5" HYDRA-STORZ ADAPTER ATTACHED TO THE BOTTOM OF THE 4 1/2" DIAMETER OUTLET.
- 9. HYDRANT SHALL BE PAINTED OSHA SAFETY YELLOW.
- 10. A 3' DIAMETER OR 3' SQUARE CONCRETE PAD SHALL BE PROVIDED AROUND HYDRANT.
- 11. ALL CAPS AND THREADS SHALL BE LUBRICATED WITH A WATERPROOF GREASE FOLLOWING INSTALLATION. METAL CAPS SHALL BE INSTALLED ON OUTLETS.
- 12. MAXIMUM DISTANCE BETWEEN FIRE HYDRANTS IS 400'(RESIDENTIAL) AND 300'(COMMERCIAL).
- 13. PAINT CURB RED FROM CENTERLINE OF FIRE HYDRANT 13' EACH WAY.


	CITY COUNCIL APPROVAL: 2-27-07	STANDARD	DRAWING NO.	/- !	5
Į	APPROVED BY CITY ENGINEER	FIRE HYDRANT	FILE NAME: W-5rev2.dwg REVISIONS	Dwn: BY	DJenkins DATE
	DUMARUTTER	CITY OF DINUBA Public Improvement Standards	Gen Notes	1	4/14/06
- 1	APPROVED BY PUBLIC WORKS DIRECTOR	1 uone improvement Standards			

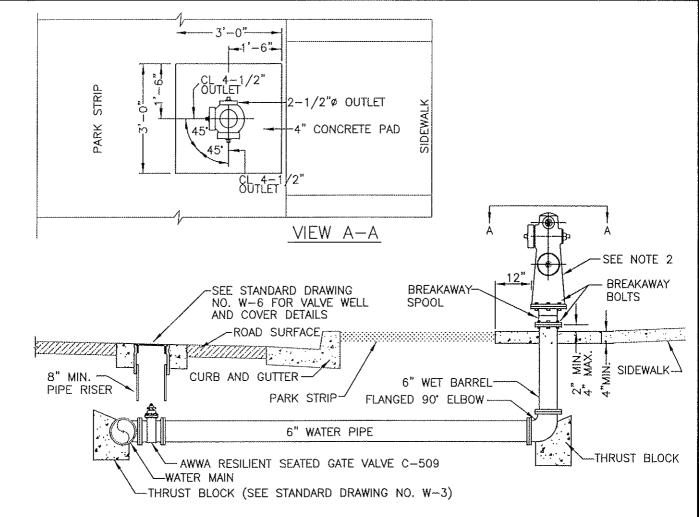


CROSS SECTION

- 1. TRADE NAMES ARE SPECIFIED AS A STANDARD OF ACCEPTABLE QUALITY AND FEATURES. EQUIPMENT OF EQUAL QUALITY WITH EQUAL FEATURES MAY BE SUBSTITUTED ONLY WITH WRITTEN APPROVA FROM THE DINUBA FIRE DEPTARTMENT.
- 2. HYDRANTS SHALL BE "CLOW" MODEL 865, WET BARREL, OR APPROVED EQUAL.
- 3. HYDRANTS SHALL HAVE (2)-4 1/2" DIAMETER OUTLETS AND (1)-2 1/2" DIAMETER OUTLET.
- 4. NOZZLE CENTERLINES SHALL BE LOCATED NOT LESS THAN 18" ABOVE FINISH GRADE.
- 5. GATE VALVES SHALL BE "RESILIENT SEAT" TYPE FLANGED TO MAIN LINE.
- 6. HYDRANT SHALL BE EQUIPPED WITH A "BREAKAWAY" TYPE SPOOL AND "BREAKAWAY" BOLTS BETWEEN HYDRANT AND RISER.
- A BLUE TWO-WAY REFLECTIVE MARKER SHALL BE INSTALLED ON THE CENTERLINE OF THE STREET ADJACENT TO THE HYDRANT.
- 8. HYDRANTS SHALL HAVE A 5" HYDRA-STORZ ADAPTER ATTACHED TO THE BOTTOM OF THE 4 1/2" DIAMETER OUTLET.
- 9. HYDRANT SHALL BE PAINTED OSHA SAFETY YELLOW.
- 10. A 3' DIAMETER OR 3' SQUARE CONCRETE PAD SHALL BE PROVIDED AROUND HYDRANT.
- 11. ALL CAPS AND THREADS SHALL BE LUBRICATED WITH A WATERPROOF GREASE FOLLOWING INSTALLATION. METAL CAPS SHALL BE INSTALLED ON OUTLETS.
- 12. MAXIMUM DISTANCE BETWEEN FIRE HYDRANTS IS 400'(RESIDENTIAL) AND 300'(COMMERCIAL).
- 13. PAINT CURB RED FROM CENTERLINE OF FIRE HYDRANT
- 13' EACH WAY. 14. REFER TO 2007 GENERAL PLAN UPDATE

14. REFER TO 2007 GENERAL FLAN OFDATE.						
CITY COUNCIL APPROVAL: 2-27-07	STANDARD FIRE HYDRANT	DRAWING NO.				
MARA K MATO		VV		<u>'u</u>		
APPROVED BY CITY ENGINEER	WITH PARK STRIPS SHOWN	FILE NAME: W-5a.dwg	Dwn:	DJenkins		
APPROVED BY CITY ENGINEER		REVISIONS	BY	DAT⊡		
Klauso (Wata	CITY OF DINUBA	Gen Notes	T.S.	4/14/06		
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APRROVED BY PUBLIC WORKS DIRECTOR	Public Improvement Standards					

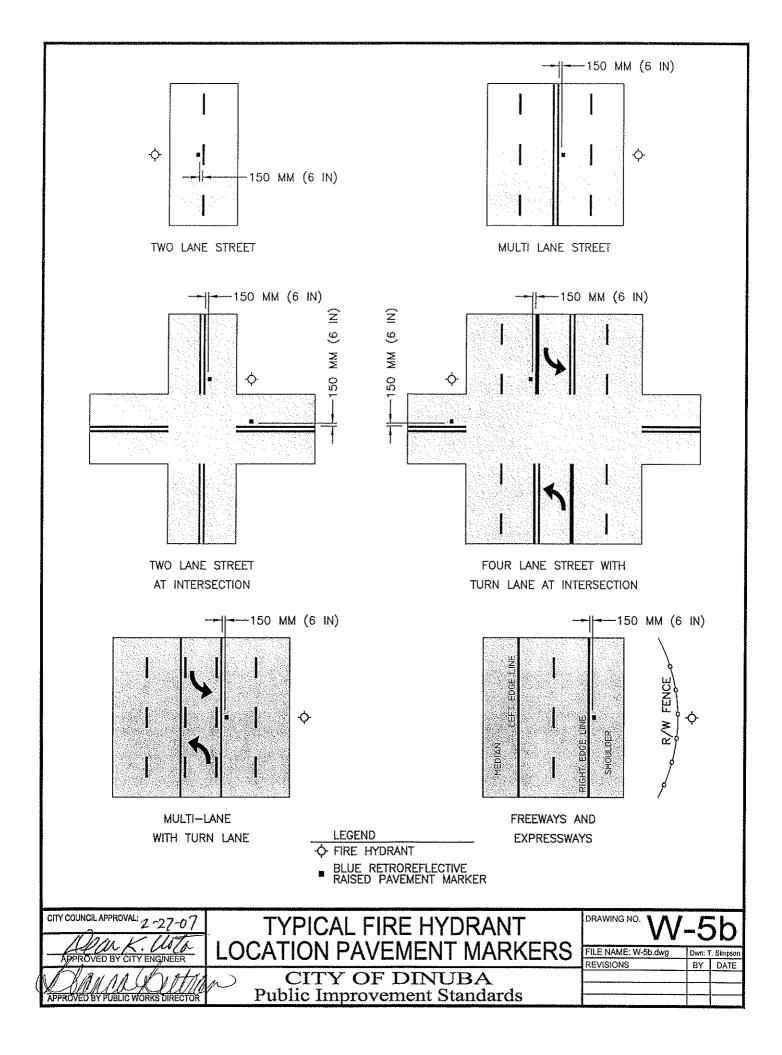

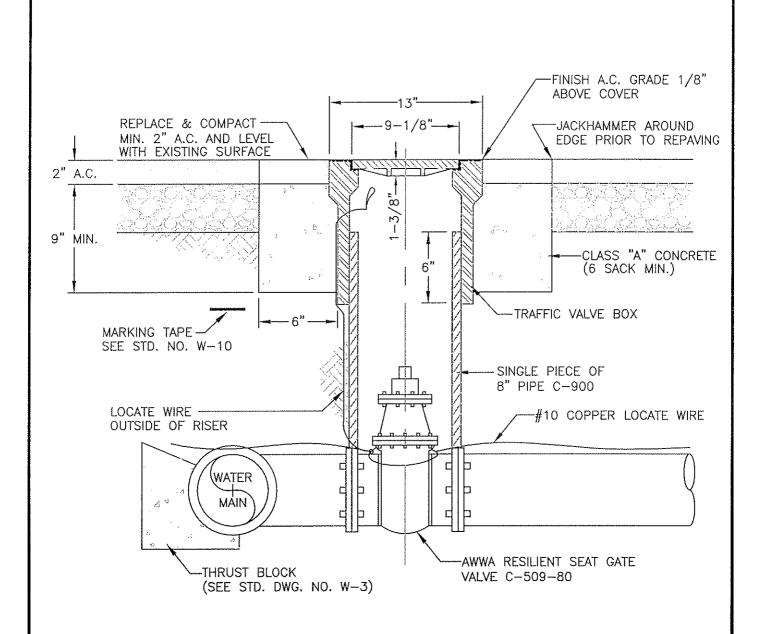

- 1. CAST IRON COVER WITH STREET TREAD INSCRIBED "WATER".
- 2. ON FIRE SPRINKLER RUNS COVER SHALL BE
- INSCRIBED "FIRE".
 3. INSTALL "CHRISTY" G5 TRAFFIC VALVE BOX 13" DIA. X 12".
- 4. MAXIMUM DISTANCE BETWEEN IN-LINE GATE VALVES IS 500 FT., OR INTERSECTION PER PLANS.

APPROVED GATE VALVES:

KENNEDY


M & H DRESSER


MUELLER


CLOW


ALL VALVES SHALL BE A.W.W.A. APPROVED RESILIENT WEDGE FLANGE X FLANGE OR MECHANICAL JOINT.


CITY COUNCIL APPROVAL: 2-27-07 DRAWING NO. VALVE WELL AND COVER FILE NAME: W-6rev1.dwg Dwn: Vasquez REVISIONS BY DATE CITY OF DINUBA Gen Notes T.S. 4/14/06 Public Improvement Standards

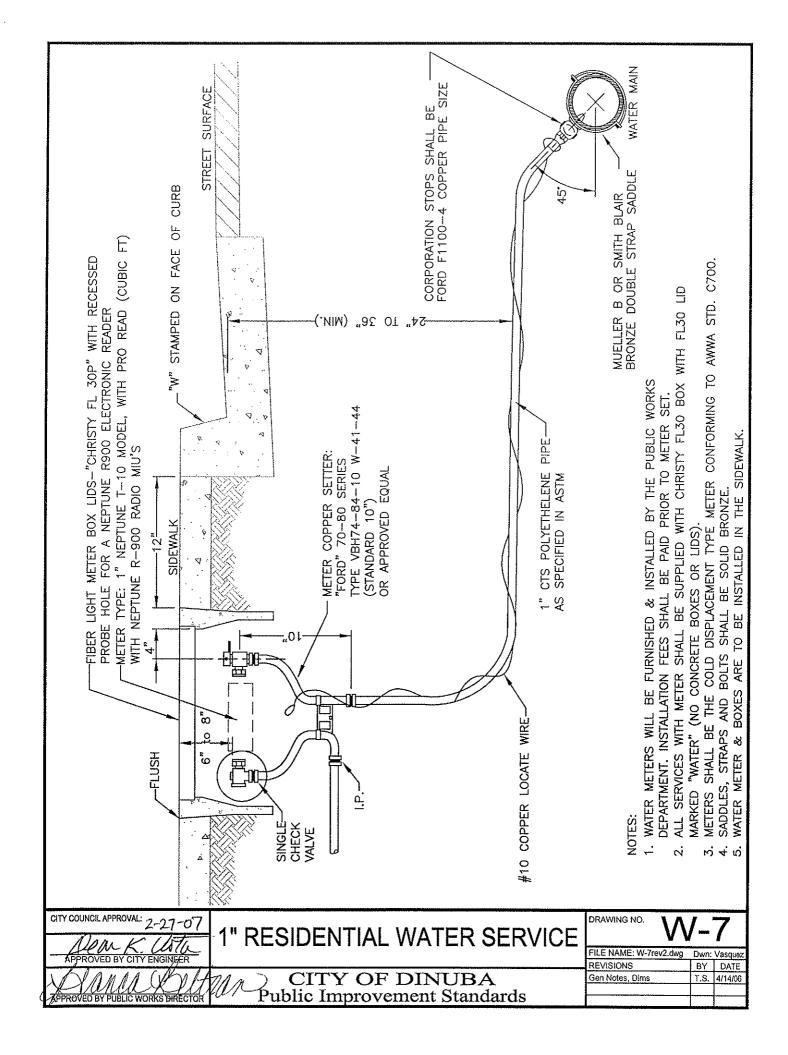

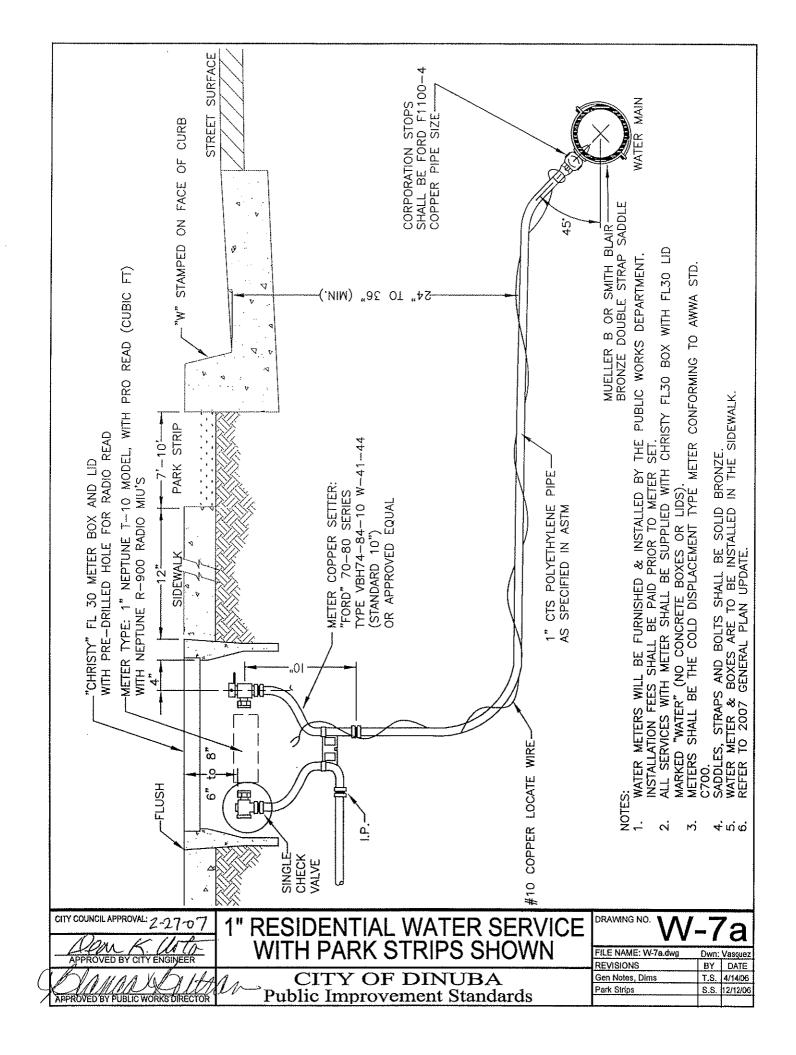

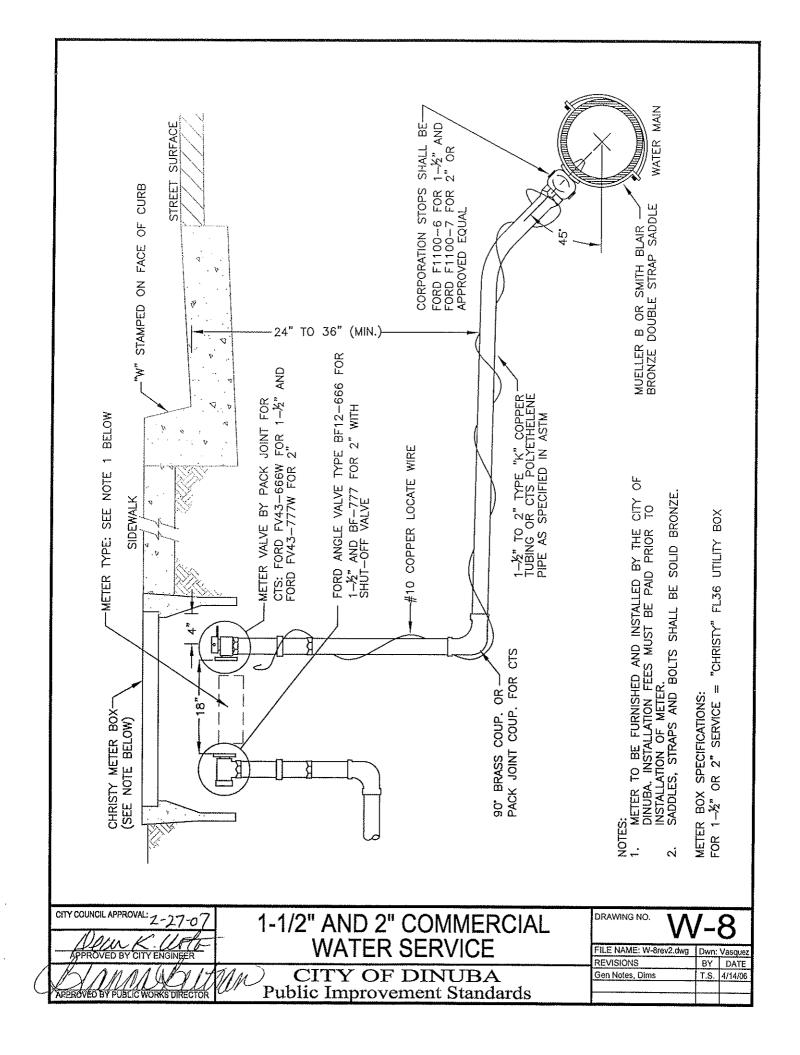

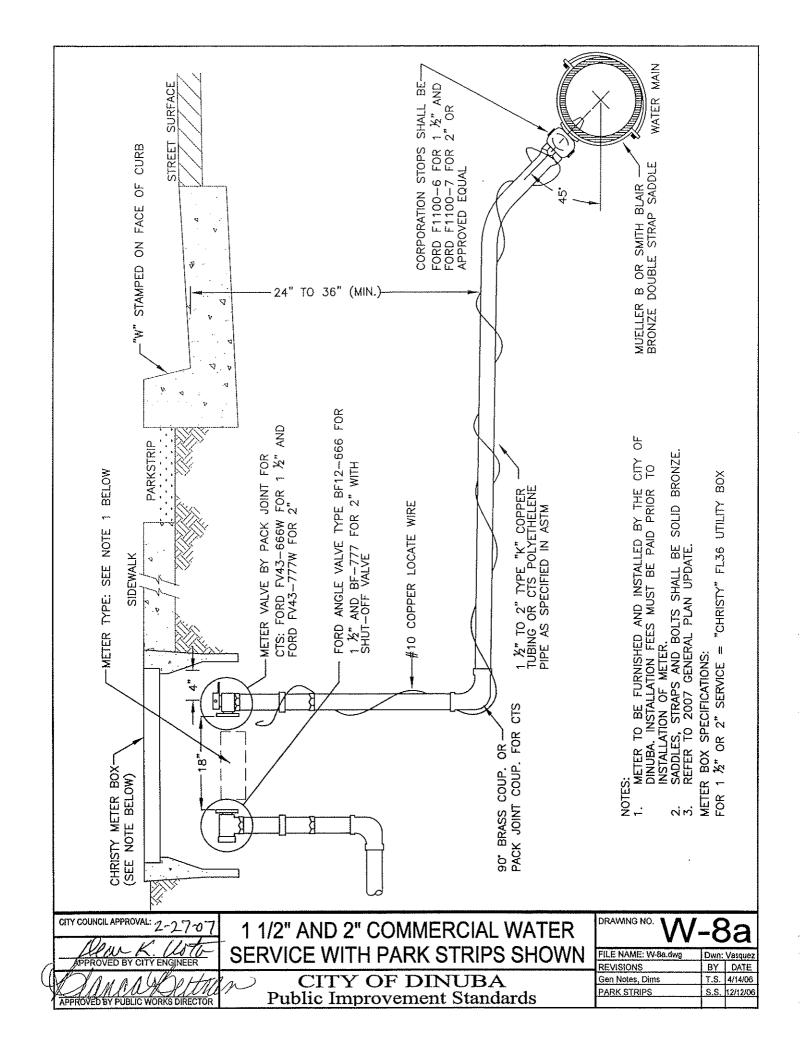


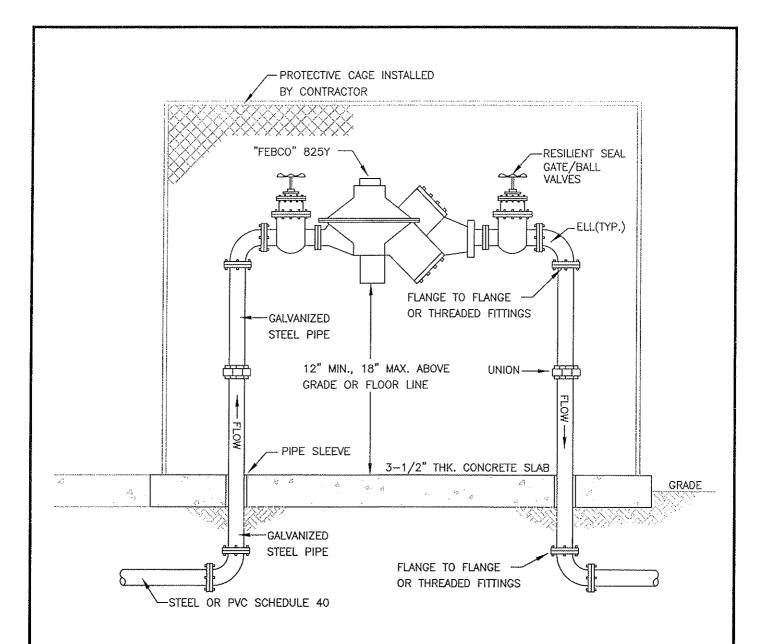

MOTES

- 1. ALL PIPE FITTINGS SHALL BE SCHEDULE 40, GALVANIZED STEEL UNLESS OTHERWISE SPECIFIED.
- 2. THE BACKFLOW PREVENTER DEVICES AND INSTALLATIONS SHALL BE APPROVED AND INSPECTED BY THE PUBLIC WORKS DEPARTMENT.
- 3. VALVE ASSEMBLIES MAY HAVE SCREWED FITTINGS OR FLANGED FITTINGS.
- 4. COAT ALL EXPOSED THREADS WITH AN APPROVED RUST INHIBITING SEALANT.
- 5. APPROVED PLASTIC TAPE, 12 MM(1/2" WIDE), SHALL BE USED ON ALL THREADED CONNECTIONS.
- 6. DISSIMILAR METALS SHALL BE SEPARATED BY AN APPROVED DIELECTRIC COUPLING.
- 7. PLASTIC PIPE SHALL NOT BE USED ABOVE FINISH GRADE.
- 8. BACKFLOW DEVICES SHALL BE TESTED BY AN APPROVED BACKFLOW TESTER OF THE INSTALLATION TYPE.

	CITY COUNCIL APPROVAL: 2-27-07	3/4" TO 2" REDUCED PRESSURE	DRAWING NO.	W -	9
	APPROVED BY CITY ENGINEER	PRINCIPAL BACKFLOW PREVENTERS	FILE NAME: W-9rev1	1.dwg Dwn: BY	: Vasquez DATE
	DAMAA DVITA	CITY OF DINUBA	Gen Notes, Callouts	T,S,	4/14/06
Ч	APPROVED BY PUBLIC WORKS DIRECTOR	Public Improvement Standards			

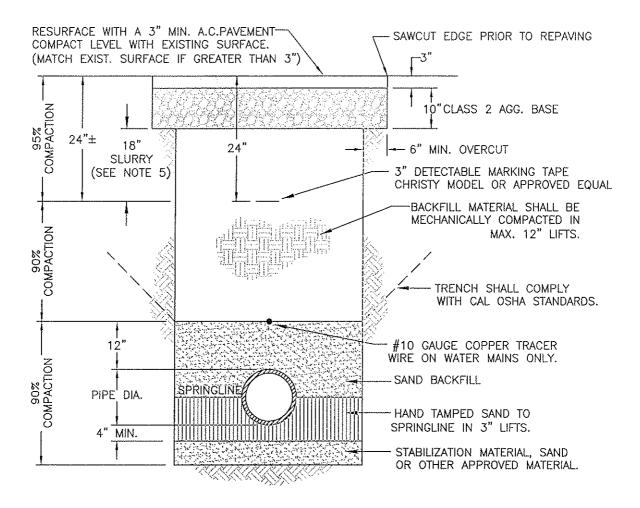

- 1. USE SPECIAL CARE IN BEDDING FLEXIBLE PIPE TO ENSURE SIDEWALL SUPPORT.
- 2. LESS COVER FOR 8" PIPE MAY BE ALLOWED AT THE DESCRETION OF THE CITY ENGINEER.
- 3. TRACE WIRE TO BE INSTALLED ON ALL WATER MAINS.
- 4. WIDTH AT BOTTOM OF TRENCH SHALL BE (O.D.+5 PIPE DIA.) WHEN UNSTABLE SOIL IS ENCOUNTERED.
- 5. MINIMUM 18" SLURRY IS REQUIRED UNDER ASPHALT IN ALL ARTERIALS AND COLLECTOR STREETS.
- 6. JETTING OF TRENCHES IS STRICTLY PROHIBITED.
- 7. MINIMUM WATER MAIN SIZE SHALL BE 8". MINIMUM SEWER MAIN SIZE SHALL BE 8". MINIMUM STORM DRAIN MAIN SIZE SHALL BE 12".
- 8. VIDEO CAMERA INSPECTION REQUIRED ON ALL CONSTRUCTED SEWER MAINS. PROVIDE REPORTS & VIDEO TAPES/CD'S.

TRENCH WIDTH

FOR 8" PIPE = 22" TO 32"

FOR 10" PIPE = 24" TO 34"

FOR 12" PIPE = 26" TO 36"

FOR 14" PIPE = 28" TO 36"

FOR 16" PIPE = 30" TO 38"

WATER, SANITARY SEWER & STORM DRAIN MAINS

8"(MIN.) THRU 12" PIPE = 42" COVER

OVER 12" PIPE = 48" COVER

CITY COUNCIL APPROVAL: 2-27-07


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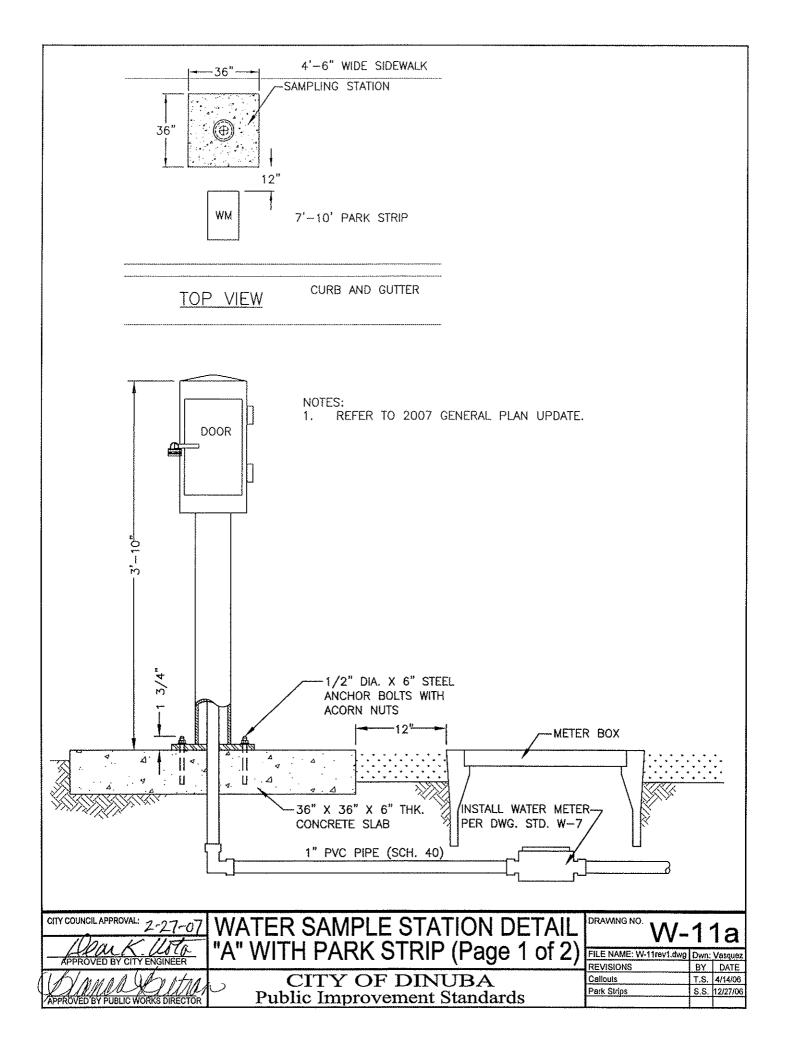
APPROVED BY CITY ENGINEER


PIPE TRENCH DETAIL


CITY OF DINUBA
Public Improvement Standards

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REVISIONS	BY	DATE
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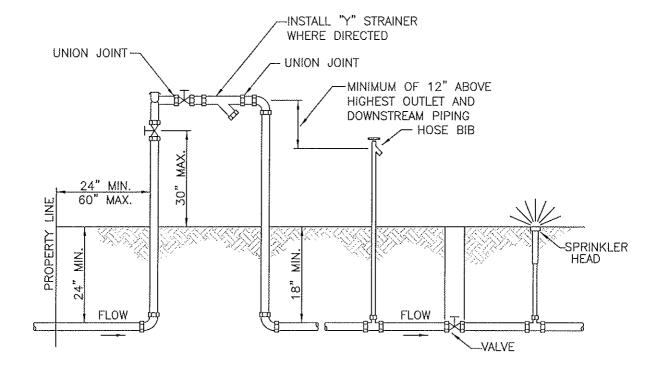


CITY OF DINUBA
Public Improvement Standards

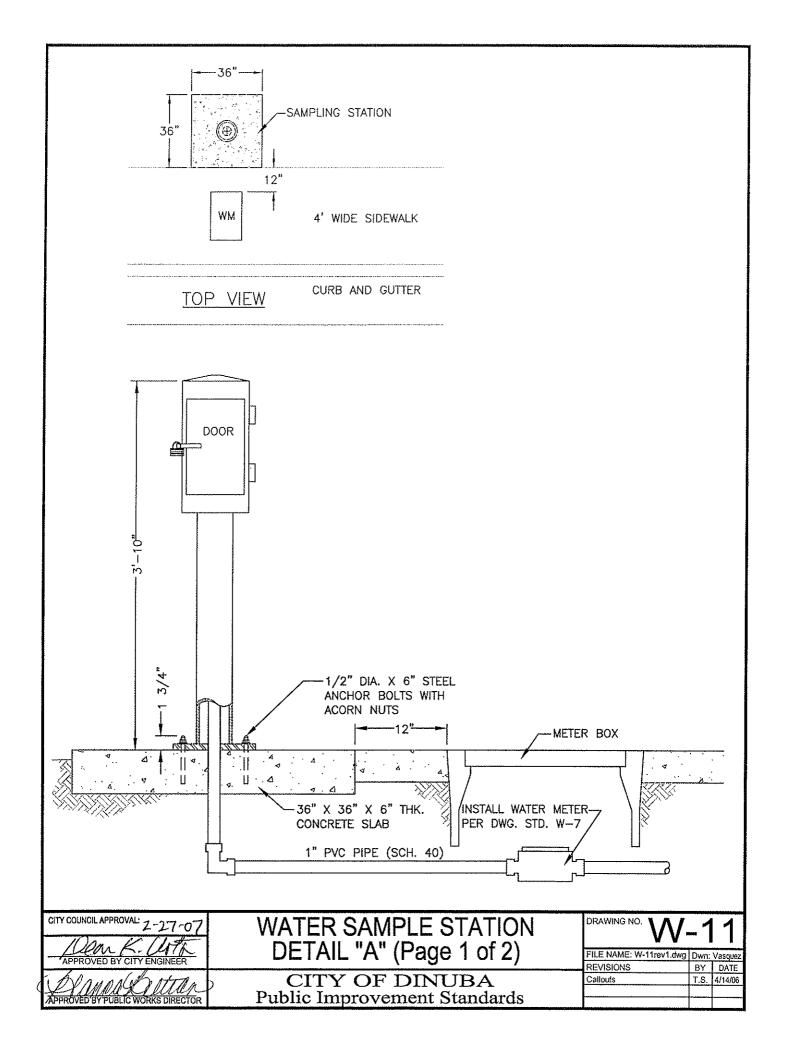T.S. 4/14/06

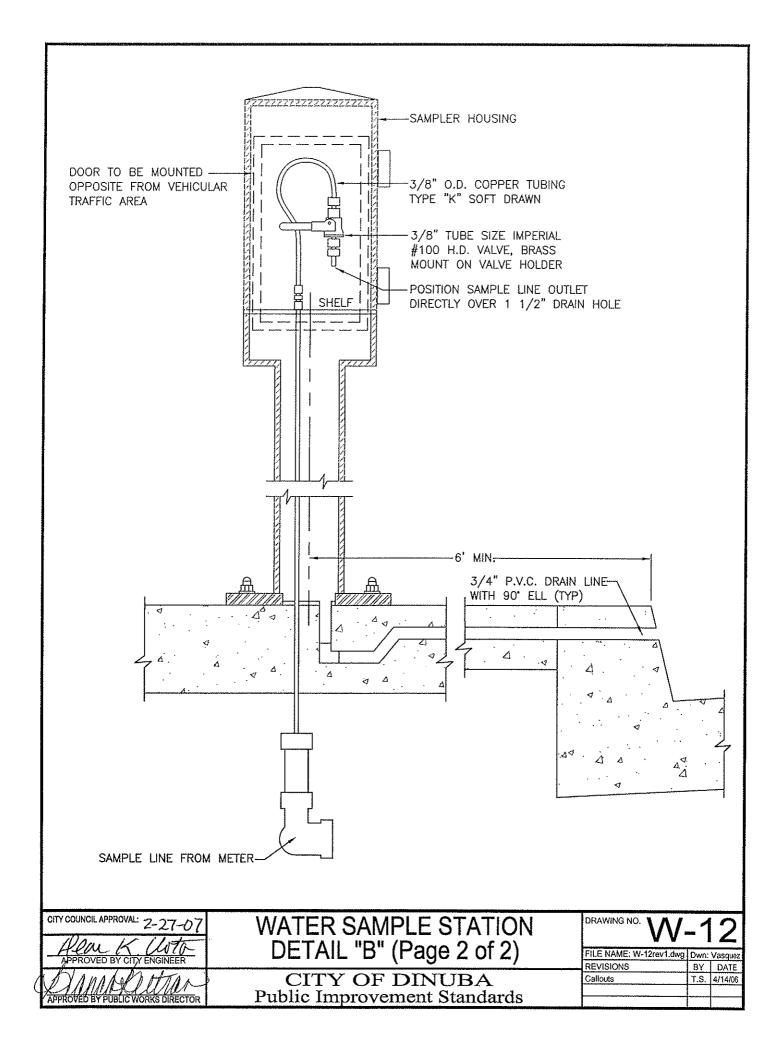
S.S. 12/27/06

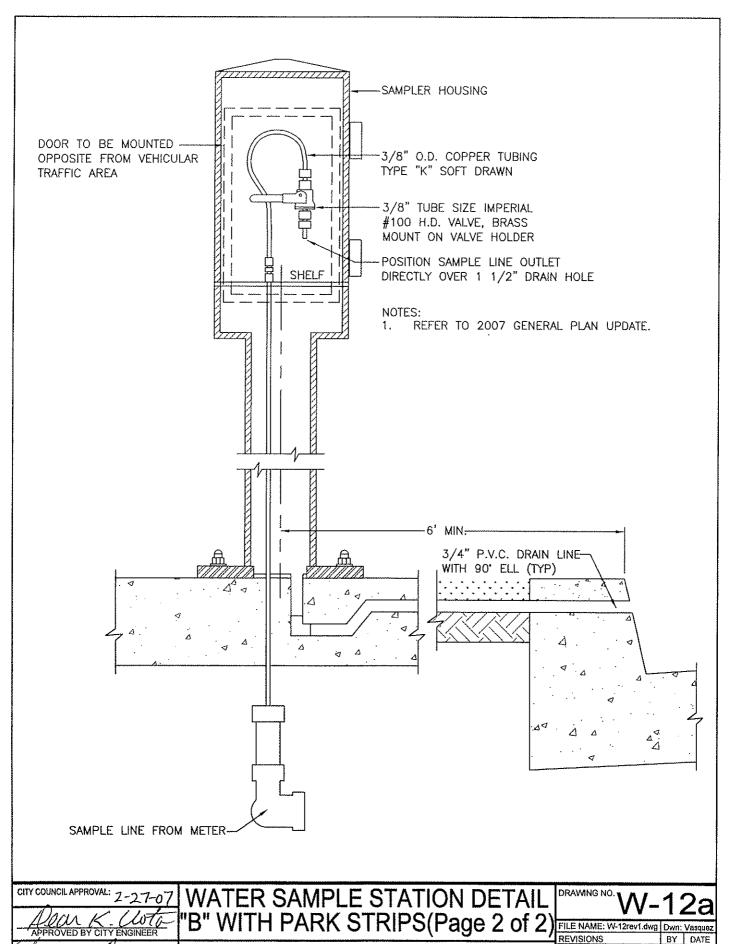
Callouts Park Strips



- RESILIENT SEATED SHUT-OFF VALVES AND TEST COCKS ARE REQUIRED.
- NO TAPS, TEES OR CONNECTIONS OF ANY KIND ARE PERMITTED BETWEEN THE WATER METER AND THE PRESSURE VACUUM BREAKER ASSEMBLY. 2.
- PROTECTION FROM FREEZE DAMAGE IS REQUIRED IN EXPOSED AREAS. 3.
- 4. ASSEMBLY MUST BE ACCESSIBLE FOR TESTING AND MAINTENANCE PER CITY OF DINUBA MUNICIPAL CODE.
- 5.
- ASSEMBLY TO BE THE SAME SIZE AS THE WATER SUPPLY LINE PER UNIFORM PLUMBING CODE. PRESSURE LOSS THROUGH PRESSURE VACUUM BREAKER ASSEMBLY MUST BE INCLUDED IN PRESSURE LOSS CALCULATIONS FOR SIZING OF THE WATER SYSTEM PER UNIFORM PLUMBING 6. CODE.
- 7. DOWNSTREAM PIPING MAY HAVE VALVES IN SYSTEM.
- NSTALL ONE UNION IN THE PIPING SYSTEM WITHIN 12 INCHES OF THE ASSEMBLY. 8.
- ASSEMBLY CAN NOT BE SUBJECT TO BACKPRESSURE FROM PUMPS, ELEVATION OR OTHER SOURCES.
- MAINTAIN A MINIMUM OF 12 INCHES, MAXIMUM OF 18 INCHES CLEARANCE AROUND ASSEMBLY. 10.
- ANY DEVIATION FROM THESE REQUIREMENTS SHALL BE APPROVED BY THE PUBLIC WORKS DEPT PRIOR TO INSTALLATION.

l	CITY COUNCIL APPROVAL: 2-27-07	PRESSURE VACUUM DREARER	DRAWING NO. W-13			
	APPROVED BY CITY ENGINEER	APPROVED BY CITY ENGINEER BACKFLOW PREVENTER INSTALLATION	FILE NAME: W-13.dwg REVISIONS		Simpson DATE	
	Grand Geltran	, CITY OF DINUBA				
ı	APPROVED BY PUBLIC WORKS DIRECTOR	Public Improvement Standards	·			

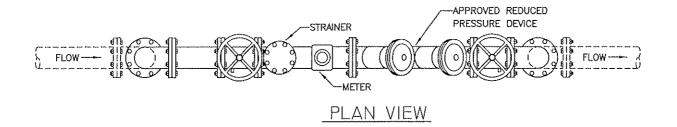

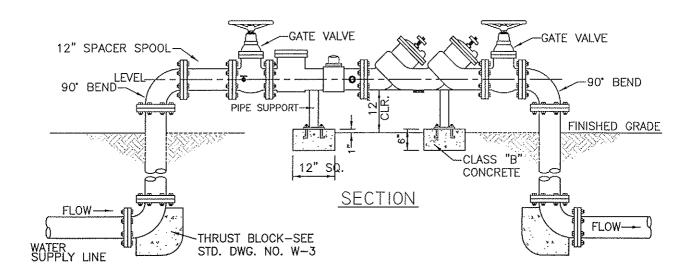


- GENERAL NOTES:

 1. INLET AND OUTLET VALVES TO BE INSTALLED AT EACH END OF ASSEMBLY.

 2. ALL WATER METERS SHALL BE "NEPTUNE" REMOTE READ.

 3. ALL WATER METERS LARGER THAN 2" SHALL BE PROVIDED BY THE OWNER, DEVELOPER OR CONTRACTOR.

CITY COUNCIL APPROVAL: 2-27-07	COMPOUND OR TURBINE METER SETTING		DRAWING NO. W-14		
APPROVED BY CITY ENGINEER	WITH REDUCED PRESSURE DEVICE	FILE NAME: W-14.dwg REVISIONS	Dwn: T. Simpson BY DATE		
APPROVED BY PUBLIC WORKS DIRECTOR	CITY OF DINUBA Public Improvement Standards				

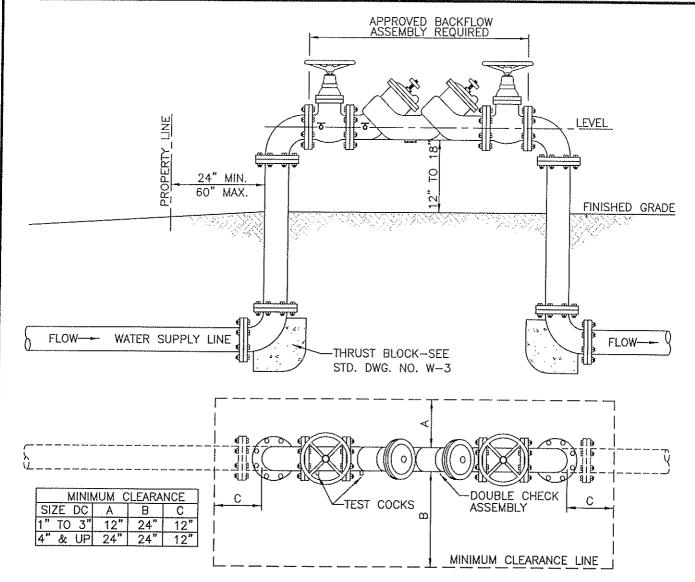

GENERAL NOTES:

- RESILIENT SEATED SHUT OFF VALVES AND TEST COCKS ARE REQUIRED
- NO TAPS, TEES OR CONNECTIONS OF ANY KIND ARE PERMITTED BETWEEN THE WATER METER AND THE BACKFLOW ASSEMBLY.
- 3. PROTECTION FROM FREEZE DAMAGE MAY BE REQUIRED IN EXPOSED AREAS.
- 4. ASSEMBLY MUST BE ACCESSIBLE FOR TESTING AND MAINTENANCE PER CITY OF DINUBA PUBLIC WORKS DEPARTMENT.
- 5. ASSEMBLY TO BE THE SAME SIZE AS THE WATER SUPPLY LINE PER UNIFORM PLUMBING CODE.
- 6. PRESSURE LOSS THROUGH ASSEMBLY MUST BE INCLUDED IN PRESSURE LOSS CALCULATIONS FOR SIZING OF THE WATER SYSTEM PER UNIFORM BUILDING CODE.
- MINIMUM CLEARANCES AROUND ASSEMBLY MUST BE MAINTAINED. REFER TO MINIMUM CLEARANCE CHART ON THIS PAGE.
- 8. DRAINAGE TO EXTERIOR OF THE BUILDING IS REQUIRED WHEN ASSEMBLY IS INSTALLED INSIDE.
- 9. ANY DEVIATION FROM THESE REQUIREMENTS SHALL BE APPROVED BY THE WATER SYSTEM MANAGER OR CROSS CONNECTION CONTROL SPECIALIST PRIOR TO INSTALLATION.
- 10. THE BACKFLOW PREVENTER DEVICES AND INSTALLATIONS SHALL BE APPROVED BY THE CITY OF DINUBA PUBLIC WORKS DEPARTMENT.
- 11. BACKFLOW ASSEMBLY SHALL BE INSPECTED AND TESTED BY THE PUBLIC WORKS DEPARTMENT OR PROVIDE A CERTIFICATE SHOWING THE ASSEMBLY WAS TESTED AND PASSED.

DOUBLE CHECK

APPROVED BY CITY ENGINEER


DOUBLE CHECK

VALVE INSTALLATION

FILE NAME: W-15.dwg | Dwn: T. Simpson

REVISIONS | BY | DATE

Public Improvement Standards

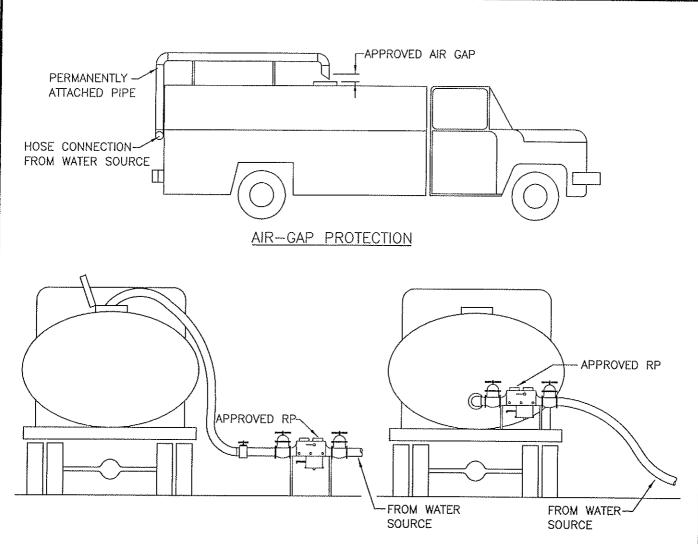

MECHANICAL ASSEMBLY PROTECTION

REQUIREMENTS:


- 1. AIR-GAP MUST BE AN APPROVED "AIR-GAP" SYSTEM
- MECHANICAL BACKFLOW PREVENTER MUST BE AN APPROVED REDUCED PRESSURE PRINCIPAL ASSEMBLY.
- 3. BACKFLOW ASSEMBLY MUST BE TESTED BY A CERTIFIED BACKFLOW PREVENTION DEVICE TESTER, WHO IS REGISTERED WITH THE CITY WATER DIVISION. THE TESTS SHALL BE PERFORMED ONCE A YEAR. THE TEST RESULTS MUST BE PROVIDED TO THE CITY WATER DIVISION.
- 4. TYPICAL EQUIPMENT: WATER TRUCKS, PEST CONTROL TRUCKS, HYDROSEEDING EQUIPMENT, PORTABLE WASHING AND STEAM CLEANING EQUIPMENT.

APPROVED PORTABLE WATER
TRANSPORT BACKFLOW PROTECTION

APPROVED BY CITY ENGINEER

CITY OF DINUBA
Public Improvement Standards

Public Improvement Standards

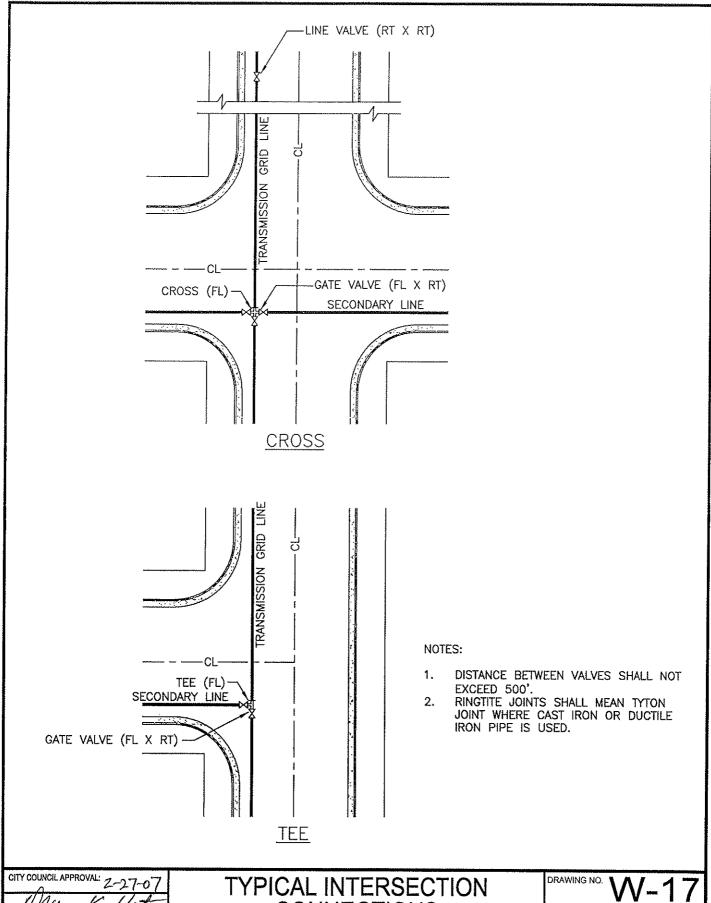


TYPICAL INTERSECTION
CONNECTIONS

FILE NAME: W-17.dwg Dwn: Simpson:
REVISIONS BY DATE

APPROVED BY PUBLIC WORKS DIRECTOR

Public Improvement Standards

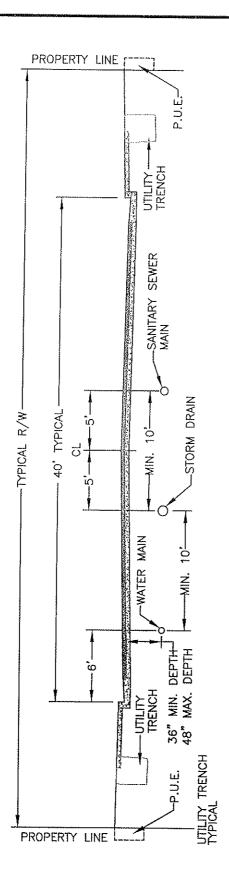

WATER MAINS AND STORM SEWER MAINS SHALL BE PLACED NORTH OR WEST OF THE CENTERLINE OF THE STREET. SEWER MAINS SHALL BE PLACED TO THE SOUTH OR EAST OF THE CENTERLINE OF THE STREET. SERVICES SHALL BE PLACED 5' FROM THE PROPERTY LINE. SERVICES SHALL BE PLACED 5' FROM THE CENTERLINE OF THE LOT. WATER SEWER

THERE SHALL BE A 10' MINIMUM DISTANCE BETWEEN WATER MAINS, SEWER MAINS AND STORM WATER MAINS.
BACKFILL IN PARKWAY OR STREET INSTALLATIONS SHALL BE AS REQUIRED BY CITY STANDARD W—10
LOCATION OF UTILITY TRENCHES SHALL BE WITHIN THE P.U.E. EXCEPT FOR CROSSINGS.
AT NO TIME WILL SANITARY SEWER LINES BE ALLOWED IN A TRENCH OCCUPIED BY PRIMARY OR SECONDARY ELECTRICAL POWER.
EACH UTILITY COMPANY MAY HAVE ONE OR MORE CONDUITS OR CONDUCTORS IN A JOINT UTILITY TRENCH.
DEPTHS TO VARY ACCORDING TO CONDUIT SIZES AND LATERAL INTERFERENCE AND UTILITY COMPANY SPECIFICATIONS. 4.3.9.6.9.4.

ALL CONDUCTORS OR CONDUITS SHALL HAVE 3" MINIMUM CLEARANCE FROM TRENCH SIDEWALL LOCATE #10 COPPER WIRE WITH ALL UTILITY MAINS AND WATER SERVICES. DRAWING NO. 1 A

MINIMUM PIPE DIAMETER FOR:

WATER MAIN:


SANITARY SEWER MAIN: STORM DRAIN MAIN:

	CITY COUNCIL APPROVAL: 2-27-07
	APPROVED BY CITY ENGINEER
(APPROVED BY PUBLIC WORKS DIRECTOR

LOCATIONS OF UTILITY MAINS

CITY OF DINUBA Public Improvement Standards

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FILE NAME: W-18.dwg	Dwn:	Lubong
REVISIONS	BY	DATE
Gen Notes	T.S.	4/14/06

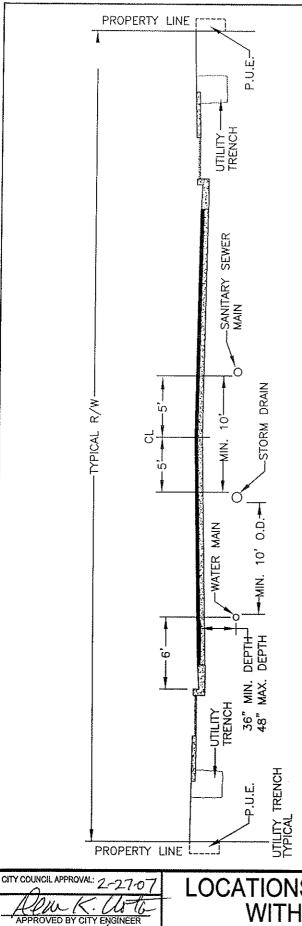

MAINS AND STORM SEWER MAINS SHALL BE PLACED NORTH OR WEST OF THE CENTERLINE OF THE STREET. MAINS SHALL BE PLACED TO THE SOUTH OR EAST OF THE CENTERLINE OF THE STREET. WATER SEWER WATER 45

SERVICES SHALL BE PLACED 5' FROM THE CENTERLINE OF THE LOT. SERVICES SHALL BE PLACED 5' FROM THE PROPERTY LINE. SEWER

THERE SHALL BE A 10' MINIMUM DISTANCE BETWEEN WATER MAINS, SEWER MAINS AND STORM WATER MAINS.

BACKFILL IN PARKWAY OR STREET INSTALLATIONS SHALL BE AS REQUIRED BY CITY STANDARD W—10

LOCATION OF UTILITY TRENCHES SHALL BE WITHIN THE P.U.E. EXCEPT FOR CROSSINGS.

AT NO TIME WILL SANITARY SEWER LINES BE ALLOWED IN A TRENCH OCCUPIED BY PRIMARY OR SECONDARY ELECTRICAL POWER.

EACH UTILITY COMPANY MAY HAVE ONE OR MORE CONDUITS OR CONDUCTORS IN A JOINT UTILITY TRENCH.

DEPTHS TO VARY ACCORDING TO CONDUIT SIZES AND LATERAL INTERFERENCE AND UTILITY COMPANY SPECIFICATIONS.

ALL CONDUCTORS OR CONDUITS SHALL HAVE 3" MINIMUM CLEARANCE FROM TRENCH SIDEWALL.

Ω ∞ 2.

SANITARY SEWER MAIN: STORM DRAIN MAIN:

WATER MAIN:

MINIMUM PIPE DIAMETER FOR DIAMETER


LOCATE #10 COPPER WIRE WITH ALL UTILITY MAINS AND WATER SERVICES. REFER TO 2007 GENERAL PLAN UPDATE.

DRAWING NO.

8a Dwn: Lubong BY DATE T.S. 4/14/06 FILE NAME: W-18a.dwg REVISIONS Gen Notes Park Strips S.S. 12/15/06

Y MAINS ONS OF WITH PARK STRIPS

CITY OF DINUBA Public Improvement Standards

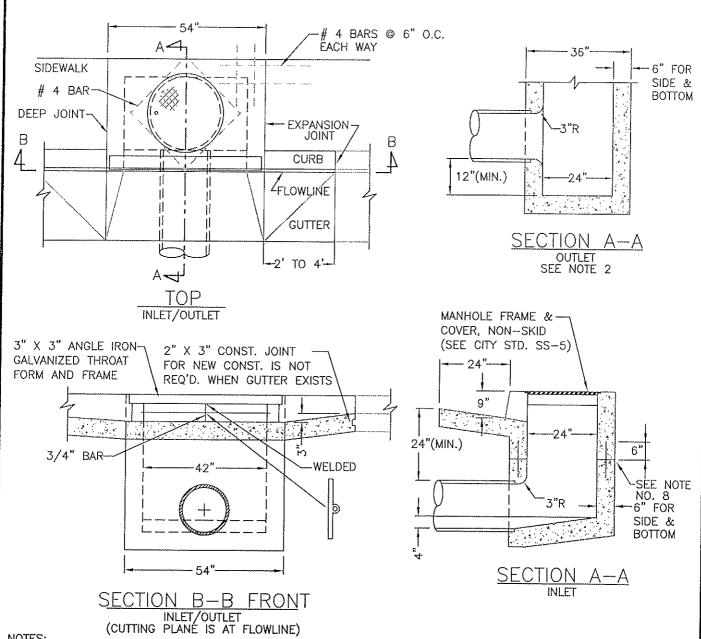

AN OUTLET STRUCTURE THROAT SHALL BE FORMED WITH 6" FROM FLOWLINE TO TOP OF CURB.

WHEN EMPLOYED AS OUTLET, ELIMINATE THE 1/2" DIA. ROD AND PLACE GALV. FRAME AND GRATE 6" BELOW TOP OF CURB. 2.

THE INLET OR OUTLET MAY BE MODIFIED SLIGHTLY TO MATCH EXISTING IMPROVEMENTS, AS DIRECTED BY THE 3. CITY.

STRUCTURE SHALL BE CLASS "A" CONCRETE (6 SACK MINIMUM). CURB, GUTTER AND LOCAL DEPRESSIONS SHALL BE CLASS "A" CONCRETE (5 SACK MINIMUM).
CURB AND GUTTER SHALL BE RECONSTRUCTED ON EACH SIDE OF BOX AS INDICATED ON THE PLANS.
THE FLOOR OF THE INLET SHALL SLOPE FROM ALL WALLS TO THE LAT. FLOWLINE AND BE GIVEN A STEEL 4.

6. TROWELED FINISH.


AT THE CONTACT POINT OF THE STRUCTURE WALL AND THE LATERAL, A SMOOTH 3"RADIUS CURVE SHALL BE 7. CONSTRUCTED. 8.

IF THE STRUCTURE IS CONSTRUCTED IN A TWO-STAGE POUR, PROVIDE A ROUGHENED CONSTRUCTION JOINT AND PLACE ON #4 REBAR, 12" LONG, IN EACH OF THE FOUR WALLS, AS SHOWN.
APPROVAL EQUAL: "CHRISTY" U36 PRE-CAST CONCRETE CATCH BASIN WITH U37(2 X 4) PRE-CAST CONCRETE


9. CURB INLET.

MAXIMUM GUTTER RUN SHALL NOT EXCEED 1,300'.

CITY COUNCIL APPROVAL: 22707 TYPE "A" CATCH BASIN DRAWING NO. 42" Curb Inlet & 42" x 24" Basin FILE NAME; SD-1rev1.dwg | Dwn: Vasquez REVISIONS BY DATE CITY OF DINUBA Gen Notes T.S. 4/14/06 Public Improvement Standards

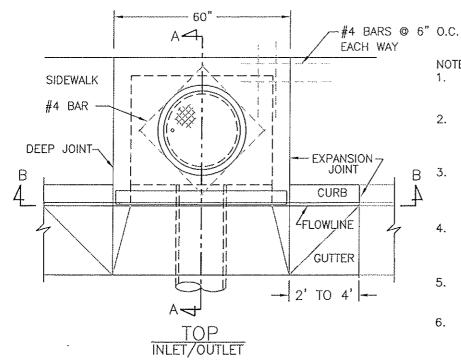


- AN OUTLET STRUCTURE THROAT SHALL BE FORMED 6" FROM FLOWLINE TO TOP OF CURB.
- THE INLET/OUTLET MAY BE MODIFIED SLIGHTLY TO MATCH EXIST IMPROVEMENTS, AS DIRECTED BY THE CITY ENGINEER.
- STRUCTURE SHALL BE CLASS "A" CONCRETE (6 SACK MINIMUM). CURB, GUTTER AND LOCAL DEPRESSIONS SHALL BE CLASS "A" CONCRETE.
- REINFORCING STEEL SHALL BE #4 DEFORMED BARS. INSTALL (2) #4 @ 24" O.C. 2" FROM & ADJACENT TO COVER FOR ADDITIONAL STRENGTH.
- SPECIAL DESIGN MAY BE REQUIRED BY THE CITY ENGINEER WHEN DEPTH OF CATCH BASIN EXCEEDS 6 FEET.
- APPROVED EQUAL: "CHRISTY" U52 PRE-CAST CONCRETE CATCH BASIN MANHOLE LID AND FRAME. (SEE CITY STD. SS-6)
- MAXIMUM GUTTER RUN SHALL NOT 7. EXCEED 1,300'.

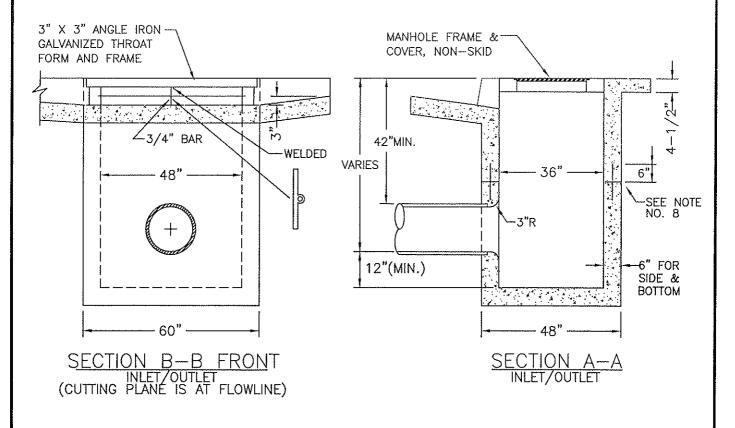


CITY COUNCIL APPROVAL:

TYPE "B" CATCH BASIN 48" Curb Inlet & 48" x 36" Basin


CITY OF DINUBA Public Improvement Standards DRAWING NO. FILE NAME; SD-2rev1.dwg | Dwn: Vasquez REVISIONS BY DATE Gen Notes T.S. 4/14/06

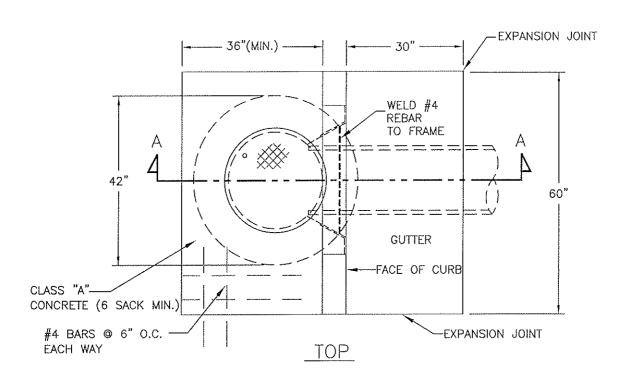


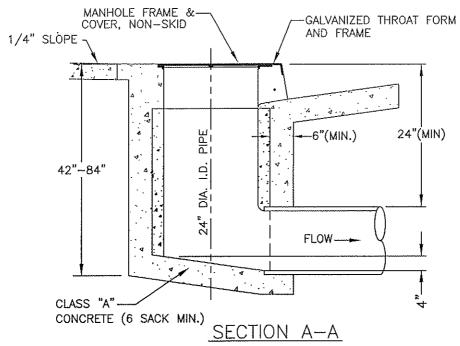

- 1. BY CITY STAFF APPROVAL ONLY.
- 2. MAXIMUM GUTTER RUN NOT TO EXCEED 1,300'.

CITY COUNCIL APPROVAL: 2-27-07	TYPE "C" CATCH BASIN	DRAWING NO. SI)-	-3
APPROVED BY CITY ENGINEER	24" Dia. Inlet Drain Pipe	FILE NAME: SD-3rev1.dwg REVISIONS	Dwn:	Vasquez DATE
APPROVED BY PUBLIC WORKS DIRECTOR	CITY OF DINUBA Public Improvement Standards	Callouts	T.S.	4/14/06

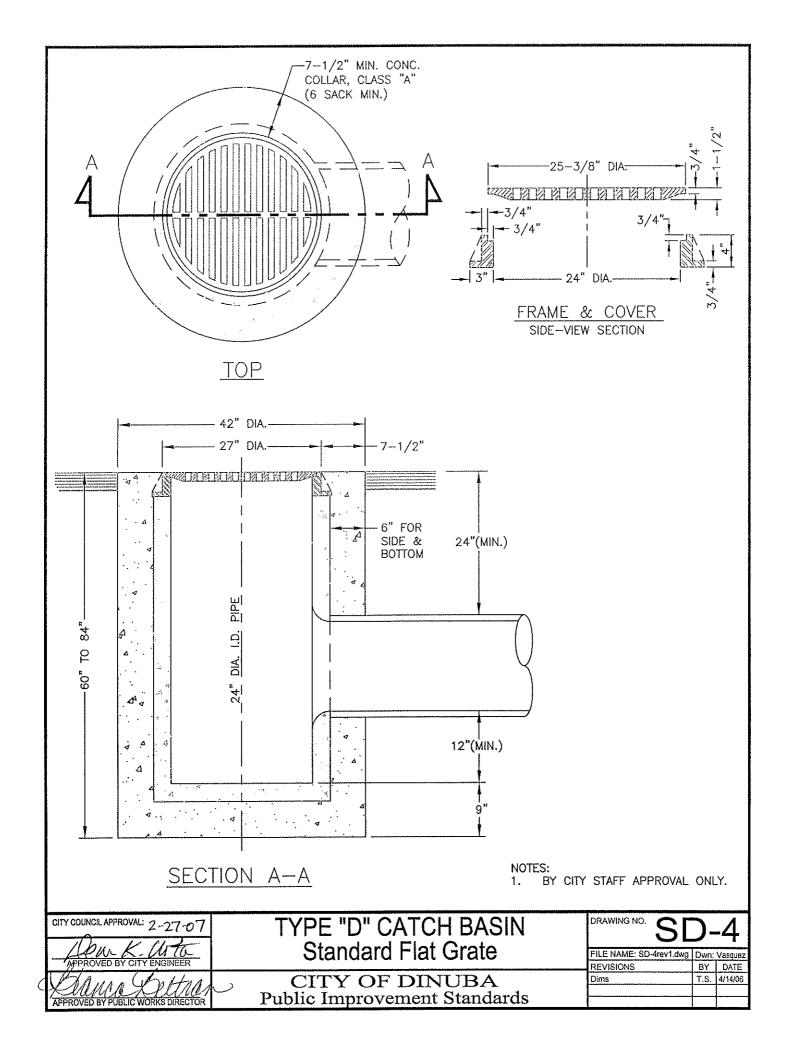


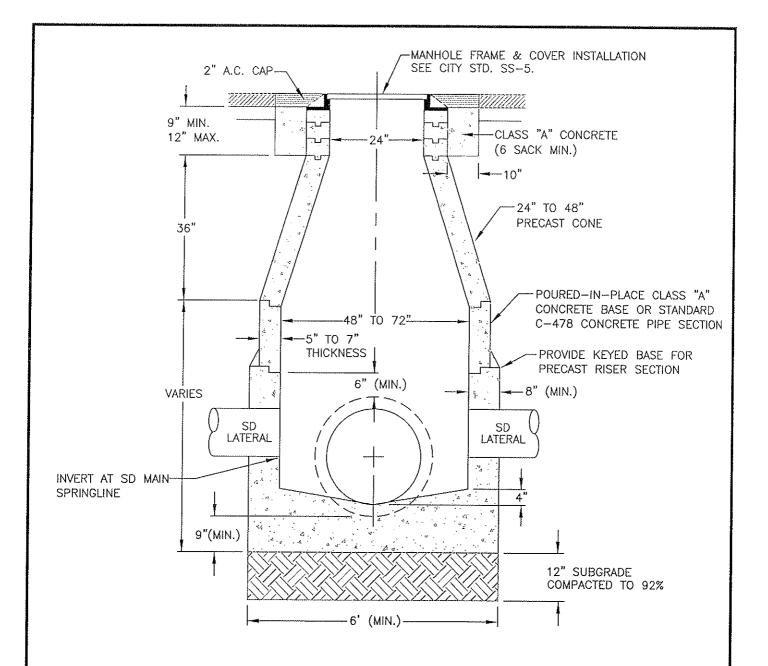


- ALL CONCRETE SHALL BE CLASS "A" (6 SACK MIN.).
 CONCRETE CONE AND GRADE RINGS SHALL BE PRECAST REINFORCED AS PER ASTM C-478. 2.
- GROUT AND BAND ALL PIPE JOINTS. "KENT" SEAL NO. 2 OR APPROVED EQUAL SHALL BE APPLIED BETWEEN 3. EACH JOINT.
- GROUT MIXTURE SHALL BE 1:2 CEMENT TO SAND.
- WHERE MANHOLES ARE NOT IN STREETS OR TRAVEL WAYS, PLACE TOP 12" ABOVE EXISTING GROUND WITH A 24" CONCRETE RING UNLESS OTHERWISE SHOWN ON THE PLANS.

 IF LARGEST PIPE SIZE IS 24" OR LARGER, A 72" DIAMETER MANHOLE IS REQUIRED.
- WHEN ADJUSTING A MANHOLE, REFER TO CITY STANDARD SS-6.
- NO FLOODING OR JETTING COMPACTION. 8.
- 9. MAXIMUM DISTANCE BETWEEN MANHOLES SHALL BE 400'.
- STORM DRAIN LATERALS 6" AND LARGER CONNECTED TO A MAIN REQUIRE A STORM DRAIN MANHOLE.




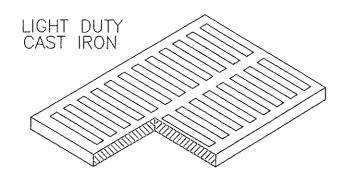

	i			
-	CATCH	I.D.	FRAME	APPROX.
	BASIN	CATCH	& GRATE	WEIGHT
	NO.	BASIN	NO.	PER SET
	U21	2'X2'	71C420	125
	U23	2'X2'	710420	125
İ	U32	2'X3'	71C430	180
	,			
	4	8% OPEN	I FLOW AR	REA

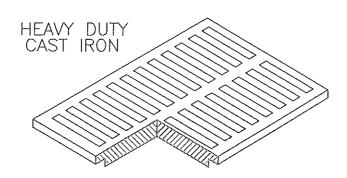

CATCH	I.D.	FRAME	APPROX.
BASIN	CATCH	& GRATE	WEIGHT
NO.	BASIN	NO.	PER SET
U21	2'X2'	71C422	230
U23	2'X2'	71C422	230
U32	2'X3'	71C432	180
	_ //.0	V FLOW AF	

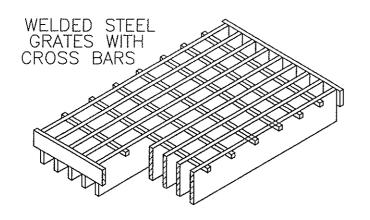


CATC	H 1.D.	FRAME	APPROX.
BASIN	√ CATCH	& GRATE	WEIGHT
NO.	BASIN	NO.	PER SET
U21	2'X2'	71W422	165
U23	2 ' X2'	71W422	165
U32	2'X3'	71W432	195
U36	2'X4'	71C442	270
U43	3'X3'	71C452	295
U52	3'X4'	71C462	390 2PC.
	77% OPEN	FLOW AF	REA

CITY COUNCIL APPROVAL: 2-27-07
APPROVED BY CITY ENGINEER
ΔM . (1)

CATCH BASIN GRATES


CITY OF DINUBA Public Improvement Standards

DRAWING NO. SE	<u>)</u> -	-6
FILE NAME: SD-6rev1.dvg	Dwn:	Vasquez
REVISIONS	BY	DATE
Gen Notes	T,S.	4/14/06

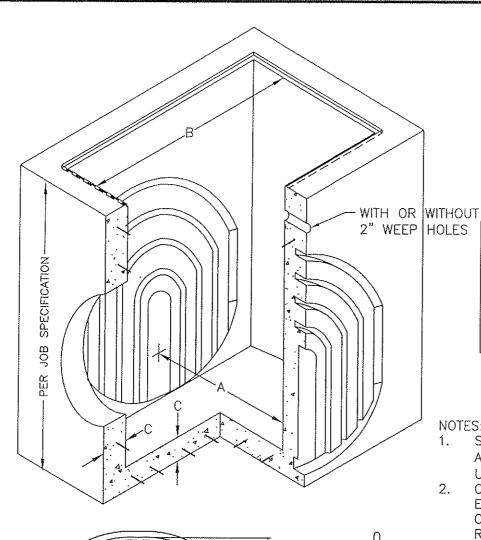


PRODUCT	DIM	ENSI	ONS
NUMBER	A	B	C
U21 U23 U32 U36 U43 U52	2' 2' 2' 2' 3' 3'	2' 2' 3' 4' 3' 4'	4" 6" 6" 5" 6"

- STANDARD GRADE RINGS ARE AVAILABLE IN 6" INCREMENTS UP TO 4' HIGH.
- 2. CUSTOMER SPECIFIED TOP EDGE CHOICES CAST INTO CATCH BASIN OR GRADE RINGS, SEE CITY STD. SD-8

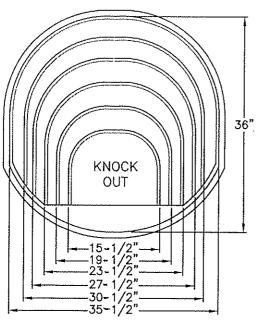



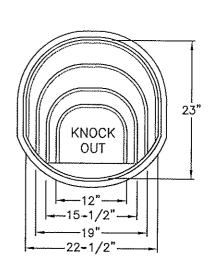


CITY COUNCIL APPROVAL: 2-27-0

"CHRISTY" U SERIES **CATCH BASINS**


CITY OF DINUBA Public Improvement Standards

DRAWING NO.	S	D-	7
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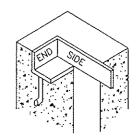
FILE NAME: SD-7rev1.dwg | Dwn: Vasquez | REVISIONS | BY | DATE T.S. 4/14/06 Gen Notes

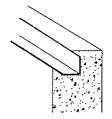


CAST-IN GALVANIZED FRAME FOR GRATES 1-1/2" X 1-1/2" ANGLE IRON WITH ANCHOR BOLTS

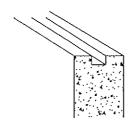


GROOVED TO RECEIVED TONGUE OF GRADE RINGS, CURB INLETS, ETC.




CAST—IN GALVANIZED FRAME FOR STATE TYPE GRATES 4"X3"X1/4" ANGLE IRON ENDS WITH ANCHOR BOLTS 3—1/2" X 1/4" SIDE BARS

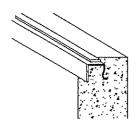

CAST—IN GALVANIZED FRAME FOR 1/4" STEEL LIDS WITH BOLT DOWN PROVISIONS

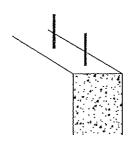


6" EXPOSED REBAR TO ALLOW JOB SITE POURING OF SPECIAL CURB SHAPES AT GRADE LEVEL, ETC.

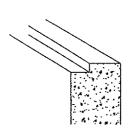

RECESSED FOR 1/4" STEEL LIDS WITH BOLT DOWN PROVISIONS

NOTES

- OPENINGS, LOCATIONS AND SIZES TO JOB SPECIFICATIONS
- 2. WITH OR WITHOUT BOTTOM.
- 3. PROGRESSIVE WEBBED KNOCK-OUTS PROVIDE MAXIMUM FLEXIBILITY PERMITTING PIPE OF ANY SIZE TO BE NEATLY AND QUICKLY GROUTED IN AT JOB SITE.
- 4. STANDARD TONGUE AND GROOVE GRADE RINGS ARE AVAILABLE IN 6" INCREMENTS UP TO 4' HIGH.
- 5. ALL REINFORCING STEEL MEETS ASTM SPECIFICATIONS AS REQUIRED.
- 6. CITY APPROVAL REQUIRED FOR APPLICATION.

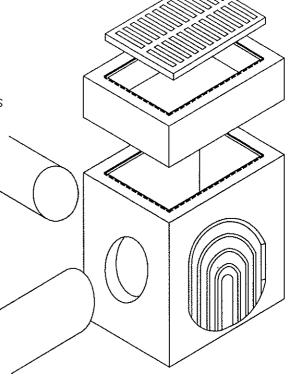



CITY COUNCIL APPROVAL: 2-27-07

TOP EDGE CHOICES FOR CATCH BASIN AND/OR GRATE RING

CITY OF DINUBA Public Improvement Standards DRAWING NO. SD-8

FILE NAME: SD-8rev1.dwg	Dwn: Vasquez		
REVISIONS	BY	DATE	
Gen Notes	T.S.	4/14/06	
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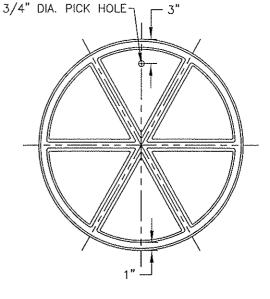


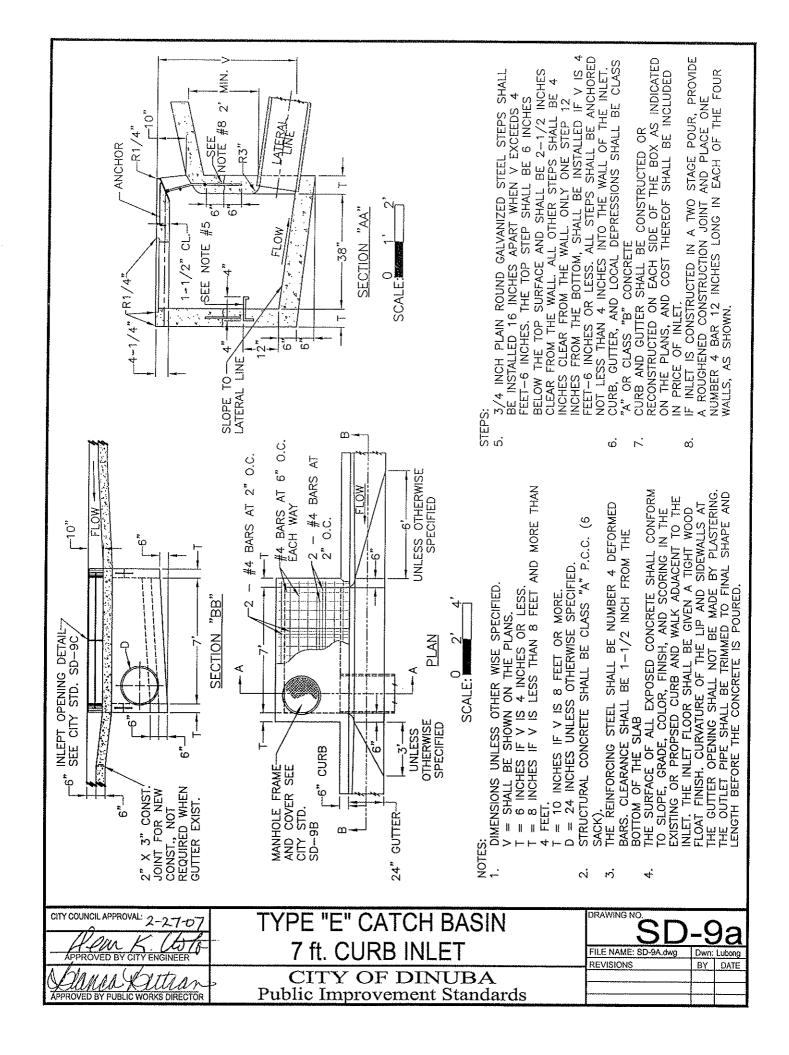

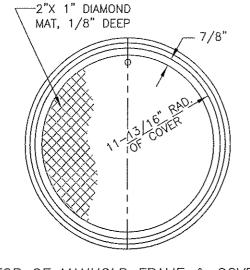TOP OF MANHOLD FRAME & COVER TOTAL WT. = 130 LBS.

0 6" 12"


SCALE:



BOTTOM OF MANHOLE COVER


0 6" 12"

SCALE:

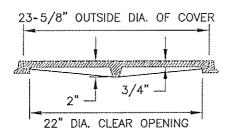


CROSS SECTION THRU FRAME & COVER



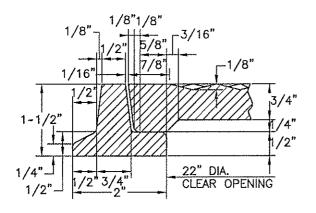

CROSS SECTION THRU RIM

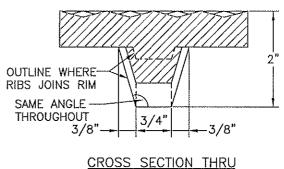

RIB AT MID RADIUS

SCALE: " 2"

NOTES:

1. FRAME AND COVER SHALL BE GRAY CAST IRON CONFROMING TO THE LATEST A.S.T.M. STANDARD A 48, CLASS 30 OR BETTER GALVANIZE PER A.S.T.M. A385.

CITY COUNCIL APPROVAL: 2-27-07


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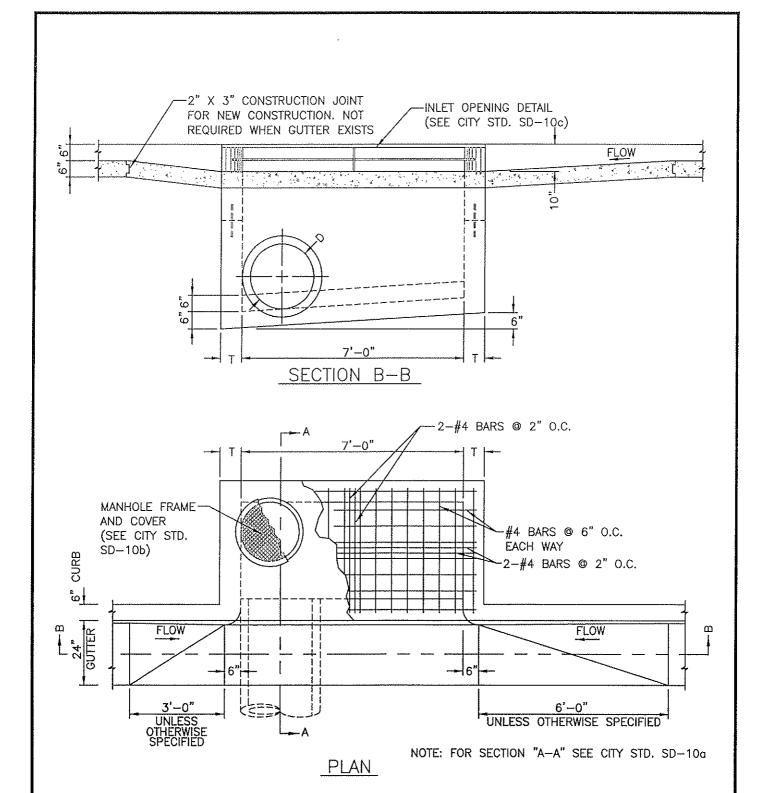
PROVED BY PUBLIC WORKS DIRECTOR

MANHOLE FRAME AND COVER FOR TYPE "E" INLET


CITY OF DINUBA
Public Improvement Standards

	SD	_(9b
	FILE NAME: SD-9B.dwg	Dwn:	Lubong
_	REVISIONS	BY	DATE
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CITY COUNCIL APPROVAL: 2-27-07	TYPE "G" INLET (page 1 of 2)	DRAWING NO. SE)-10
APPROVED BY CITY ENGINEER	(F-9	FILE NAME: SD-10.dwg REVISIONS	Dwn: T. Simpson BY DATE
Drugg Getran	CITY OF DINUBA		
APPROVED BY PUBLIC WORKS DIRECTOR	Public Improvement Standards		

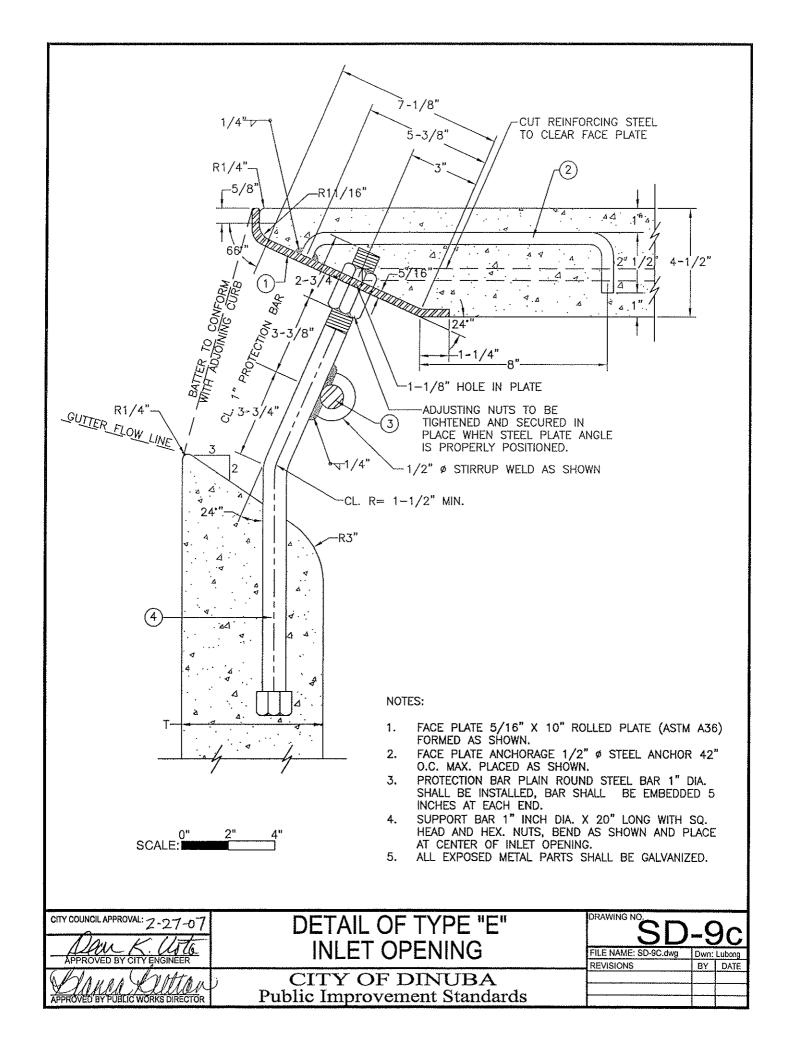


DIMENSIONS: UNLESS OTHERWISE SPECIFIED V=SHALL BE SHOWN ON THE PLANS T=6" IF V IS 4' OR LESS. T=8" IF V IS LESS THAN 8' AND MORE THAN 4'.

T=10" IF V IS 8' OR MORE.

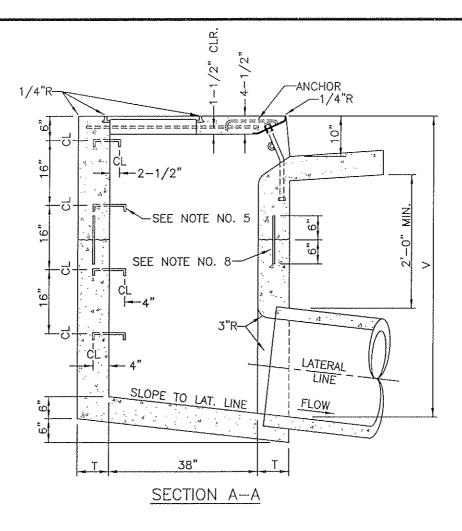
D=24" UNLESS OTHERWISE SPECIFIED.

- STRUCTURAL CONCRETE SHALL BE CLASS "A" (6 SACK MIN.).
- THE REINFORCING STEEL SHALL BE #4 DEFORMED BARS, CLEARANCE SHALL BE 1-1/2" FROM THE BOTTOM OF THE SLAB.
- THE SURFACE OF ALL EXPOSED CONCRETE SHALL CONFORM TO SLOPE, GRADE, COLOR, FINISH AND SCORING IN THE EXISTING OR PROPOSED CURB AND WALK ADJACENT TO THE INLET. THE INLET FLOOR SHALL BE GIVEN A TIGHT WOOD FLOAT FINISH, CURVATURE OF THE LIP AND SIDEWALLS AT THE GUTTER OPENING SHALL NOT BE MADE BY PLASTERING. THE OUTLET PIPE SHALL BE TRIMMED TO FINAL SHAPE AND LENGTH BEFORE THE CONCRETE IS POURED.
- STEPS: 3/4" PLAIN ROUND GALVANIZED STEEL STEPS SHALL BE INSTALLED 16" APART WHEN V EXCEEDS 4'-6". THE TOP STEP SHALL BE 6" BELOW THE TOP SURFACE AND SHALL BE 2-1/2" CLEAR FROM THE WALL, ALL OTHER STEPS SHALL BE 4" CLEAR FROM THE WALL, ONLY ONE STEP 12" FROM THE BOTTOM SHALL BE INSTALLED IF V IS 4'-6" OR LESS. ALL STEPS SHALL BE ANCHORED NOT LESS THAN 4" INTO THE WALL OF THE INLET.
- CURB, GUTTER AND LOCAL DEPRESSIONS SHALL BE CLASS "A" OR CLASS "B" CONCRETE.
- CURB AND GUTTER SHALL BE CONSTRUCTED OR RECONSTRUCTED ON EACH SIDE OF BOX AS INDICATED ON THE PLANS, AND COST THEREOF SHALL BE INCLUDED IN PRICE OF INLET.
- IF INLET IS CONSTRUCTED IN A TWO STAGE POUR, PROVIDE A ROUGHENED CONSTRUCTION JOINT AND PLACE 1-#4 BAR 12" LONG IN EACH OF THE FOUR WALLS, AS SHOWN.


CITY COUNCIL APPROVAL: 1-27-07 TYPE "	G" INLET (page 2 of 2)	-10a
APPROVED BY CITY ENGINEER	FILE NAME: SD-10a.dwg	Own: T. Simpson BY DATE
	TY OF DINUBA mprovement Standards	

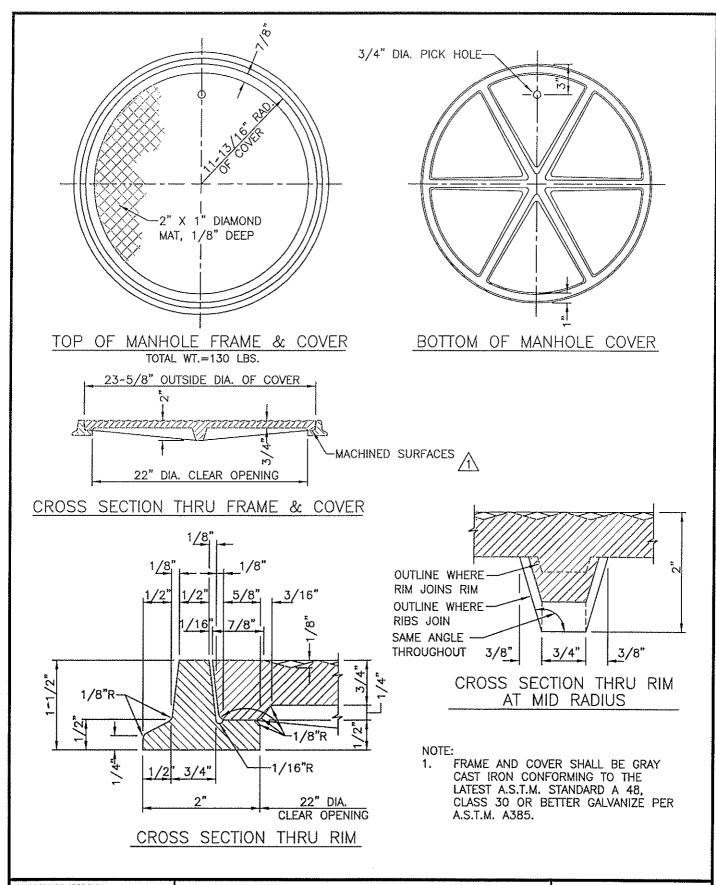


	CITY COUNCIL APPROVAL: 2-27-07		DRAWING NO. SD	-10	b
	APPROVED BY CITY ENGINEER	FOR TYPE "G" INLET	FILE NAME: SD-10b.dwg REVISIONS	Dwn: T. Simp	
1	Danea Sutran	CITY OF DINUBA			_
	APPROVED BY PUBLIC WORKS DIRECTOR	Public Improvement Standards			

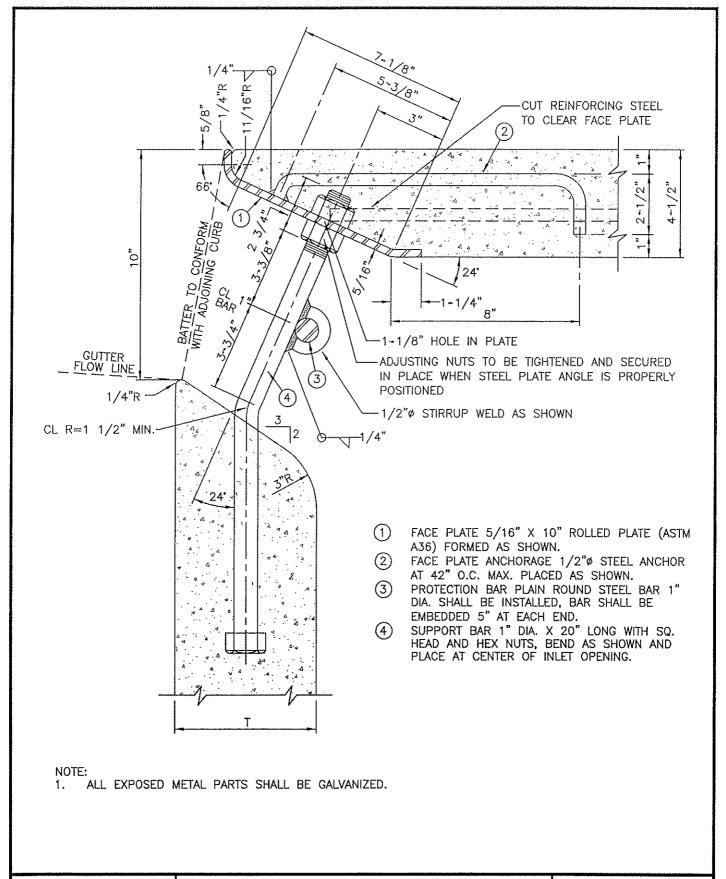

CITY COUNCIL APPROVAL: 2-27-07	DEIAIL OI TITL O	DRAWING NO. SD	-10c
APPROVED BY CITY ENGINEER	INLET OPENING	FILE NAME: SD-10c.dwg REVISIONS	Dwn: T. Simpson BY DATE
APPROVED BY PUBLIC WORKS DIRECTOR	CITY OF DINUBA Public Improvement Standards		

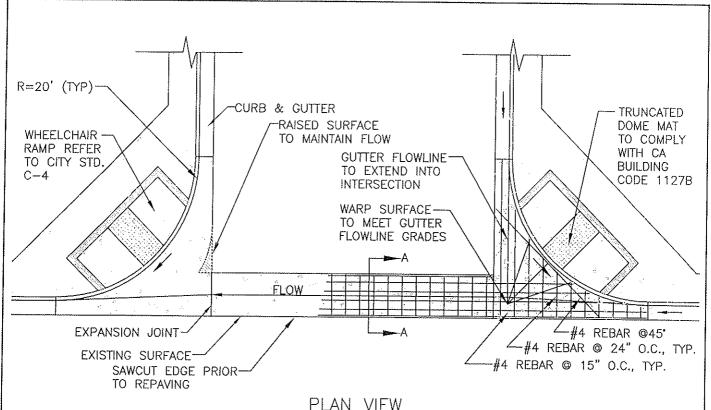


PLAN VIEW

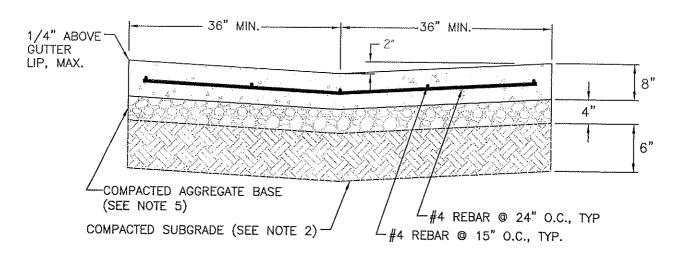


SECTION A-A

- 1. MATERIAL SHALL BE CLASS "A" CONCRETE (6 SACK MINIMUM).
- 2. COMPACT SUBGRADE TO 95% RELATIVE COMPACTION, PER ASTM D1557.
- 3. WIDER CROSS GUTTER MAY BE REQUIRED.
- 4. THE VALLEY GUTTER SHALL HAVE A MINIMUM SLOPE OF 0.0030 IN THE DIRECTION OF FLOW.
- 5. BASE SHALL BE 4 INCHES CLII AGGREGATE BASE, TO 95% RELATIVE COMPACTION PER ASTM D1557.

POUNCIL APPROVAL: 2-27-07	VALLEY GUTTER	DRAWING NO.	2-1
APPROVED BY CITY ENGINEER		FILE NAME: C-1.dwg REVISIONS	Dwn: C.Tamez
PROVED BY PUBLIC WORKS DIRECTOR	CITY OF DINUBA Public Improvement Standards	Truncated Dome	BY DATE T.S. 4/14/06

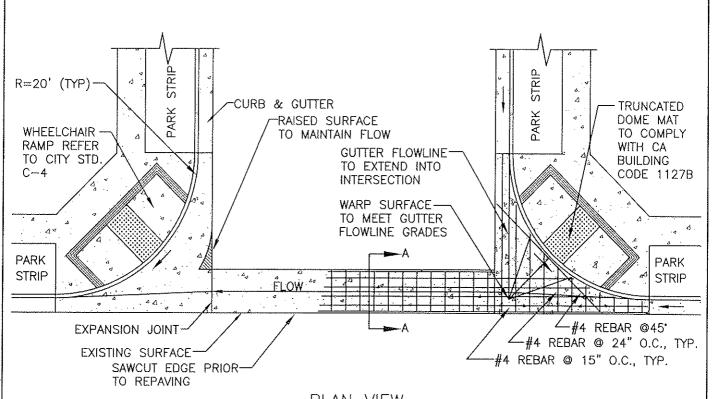


PLAN VIEW

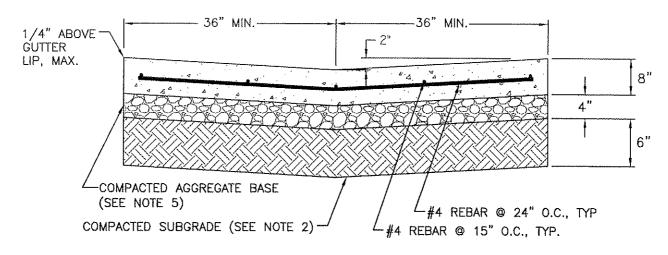

SECTION A-A

- 1. MATERIAL SHALL BE CLASS "A" CONCRETE (6 SACK MINIMUM).
- 2. COMPACT SUBGRADE TO 95% RELATIVE COMPACTION, PER ASTM D1557.
- 3. WIDER CROSS GUTTER MAY BE REQUIRED.
- 4. THE VALLEY GUTTER SHALL HAVE A MINIMUM SLOPE OF 0.0030 IN THE DIRECTION OF FLOW.
- 5. BASE SHALL BE 4 INCHES CLII AGGREGATE BASE, TO 95% RELATIVE COMPACTION PER ASTM D1557.
- 6. REFER TO 2007 GENERAL PLAN UPDATE.


	CITY COUNCIL APPROVAL: 2-27-07	VALLET GUITER	DRAWING NO. C-	-1	a
	APPROVED BY CITY ENGINEER	WITH PARK STRIPS SHOWN	FILE NAME: C-1a.dwg REVISIONS	Dwn: (C.Tamez DATE
4	Day of Sottian	CITY OF DINUBA	Truncated Dome		4/14/06
1	APPROVED BY PUBLIC WORKS DIRECTOR	Public Improvement Standards	Park Strips	KRG	8/14/06
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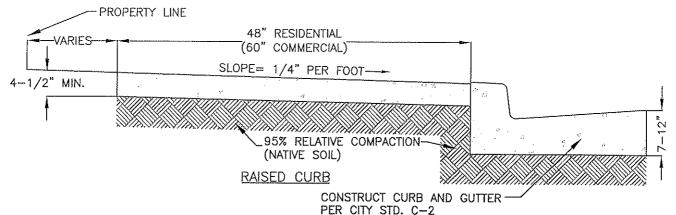


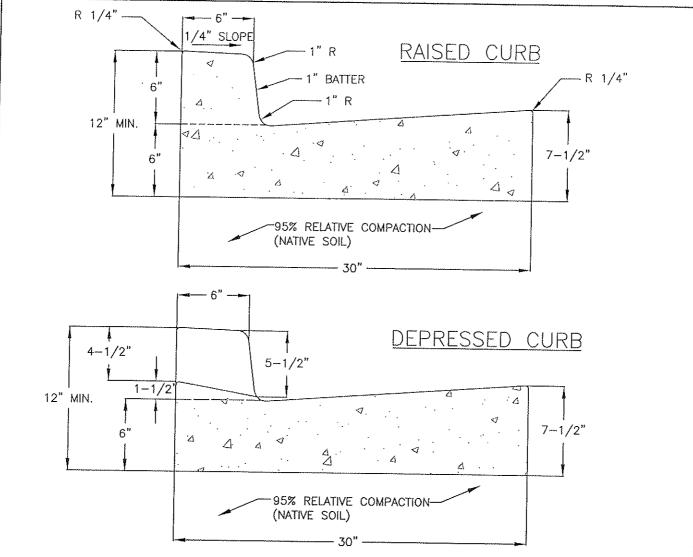- 1. THE 30" STANDARD APPLIES TO ALL CURB & GUTTER EXCEPT THE "DOWNTOWN STREETSCAPE AREA".
- 2. FORMS TO REMAIN FOR A MINIMUM OF 24 HOURS.
- 3. WOOD FORMS SHALL HAVE A NOMINAL THICKNESS OF 2", EXCEPT ON CURVE CONSTRUCTION WHERE THE THICKNESS SHALL BE DETERMINED BY THE CITY INSPECTOR.
- 4. MINIMUM GRADE FOR CURB & GUTTER SHALL NEVER BE LESS THAN .0015 SLOPE, EXCEPT CURVE PORTIONS OF CUL-DE-SAC STREETS WHICH SHALL HAVE .0020 SLOPE MINIMUM.
- 5. LINE & GRADE STAKES ARE TO BE SET 3' FROM FACE OF CURB.STAKE SPACING SHALL BE 25' MAXIMUM FOR A SLOPE OF .0015 AND 50' MAXIMUM FOR SLOPES OF .0020 OR MORE (OR EQUIVALENT CONTROLS).
- 6. EXPANSION JOINTS 1/2" WIDE SHALL BE INSTALLED IN CURB AT 60' INTERVALS (MINIMUM 30'), AND EACH SIDE OF THE DRIVE APPROACH.
- 7. WEAKENED PLANE JOINTS SHALL BE CONSTRUCTED 15' ON CENTER AND SHALL BE MINIMUM DEPTH OF 1-1/2" TO 2" WITH A SCORING TOOL LEAVING THE EDGES ROUNDED.
- 8. SEE CONCRETE NOTES AND CITY STANDARD SPECIFICATIONS.
- 9. CONCRETE SHALL BE TYPE "A" CONCRETE (6 SACK MINIMUM).

ABUK. UTO	STANDARD 30" CURB & GUTTER	DRAWING NO.	J-2
APPROVED BY CITY ENGINEER		FILE NAME: C-2.dwg	Dwn; C.Tamez
PROVED BY PUBLIC WORKS DIRECTOR	CITY OF DINUBA Public Improvement Standards	Note 9	BY DATE T.S. 4/14/06







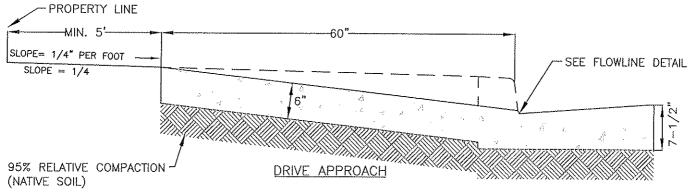


- . SIDEWALKS SHALL HAVE AN EVEN TROWEL FINISH AND A MEDIUM BROOM FINISH ACROSS THE SLOPE.
- HEIGHT OF CURB FACE SHALL BE 6".
- BACK OF CURB FACE SHALL BE 12".
- 4. ALL SIDEWALK AND DRIVE APPROACH CONCRETE WORK SHALL BE OF CLASS "B" CONCRETE (5 SACK MINIMUM). CURB AND GUTTER SHALL BE OF CLASS "A" CONCRETE (6 SACK MINIMUM).
- 5. EXPANSION JOINTS 1/2" WIDE SHALL BE INSTALLED IN CURB AT 60' INTERVALS (MINIMUM 30'), AND EACH SIDE OF DRIVE APPROACH WING.
- 6. WEAKENED PLANE JOINTS SHALL BE CONSTRUCTED 15' ON CENTER AND SHALL BE A MINIMUM DEPTH OF 1-1/2" TO 2" WITH A SCORING TOOL LEAVING THE EDGES ROUNDED.
- 7. SCORING PATTERN (SIDEWALK) SHALL BE AT 5' INTERVALS WITH SCORING TOOL 1/2" DEEP.

Y COUNCIL APPROVAL: 2-27-07	CURB, GUTTER & SIDEWALK	DRAWING NO.	C-3
APPROVED BY CITY ENGINEER	•	FILE NAME: C-3.dwg	Dwn: C,Tame
PROVED BY PUBLIC WORKS DIRECTOR	CITY OF DINUBA Public Improvement Standards	REVISIONS Note 4	T.S. 4/14/00

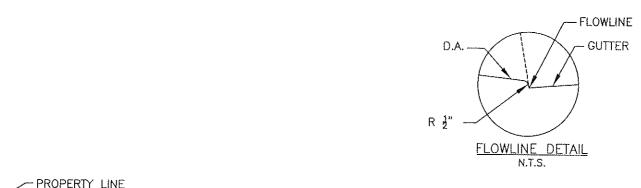

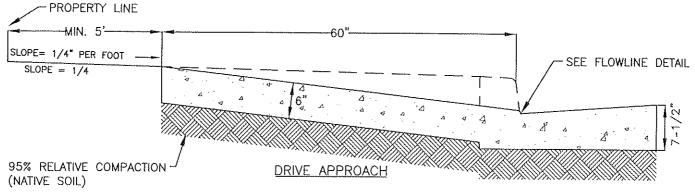

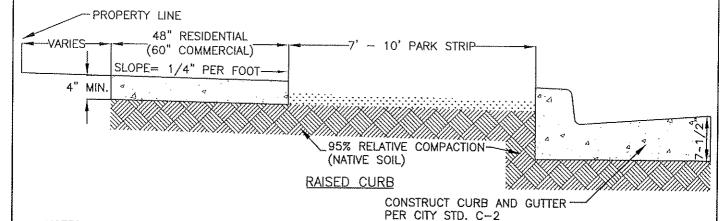

- 1. SIDEWALKS SHALL HAVE AN EVEN TROWEL FINISH AND A MEDIUM BROOM FINISH ACROSS THE SLOPE.
- 2. HEIGHT OF CURB FACE SHALL BE 6".
- 3. BACK OF CURB FACE SHALL BE 12".
- 4. ALL SIDEWLK AND DRIVE APPROACH CONCRETE WORK SHALL BE OF CLASS "B" CONCRETE (5 SACK MINIMUM). CURB AND GUTTER SHALL BE OF CLASS "A" CONCRETE (6 SACK MINIMUM).
- 5. EXPANSION JOINTS 1/2" WIDE SHALL BE INSTALLED IN CURB AT 60' INTERVALS (MINIMUM 30'), AND EACH SIDE OF DRIVE APPROACH WING.
- 6. WEAKENED PLANE JOINTS SHALL BE CONSTRUCTED 15' ON CENTER AND SHALL BE A MINIMUM DEPTH OF 1 1/2" TO 2" WITH A SCORING TOOL LEAVING THE EDGES ROUNDED.
- 7. SCORING PATTERN (SIDEWALK) SHALL BE AT 5' INTERVALS WITH SCORING TOOL 1/2" DEEP.

CITY COUNCIL APPROVAL: 2-27-07

APPROVED BY CITY ENGINEER


APPROVED BY PUBLIC WORKS DIRECTOR

CURB, GUTTER & SIDEWALK

CITY OF DINUBA
Public Improvement Standards


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FILE NAME: C-3a.dwg Dwn: C.Tame		C.Tamez
REVISIONS	BY	DATE
Note 4	T.S.	4/14/06
Park Strip	KRG	8/14/06

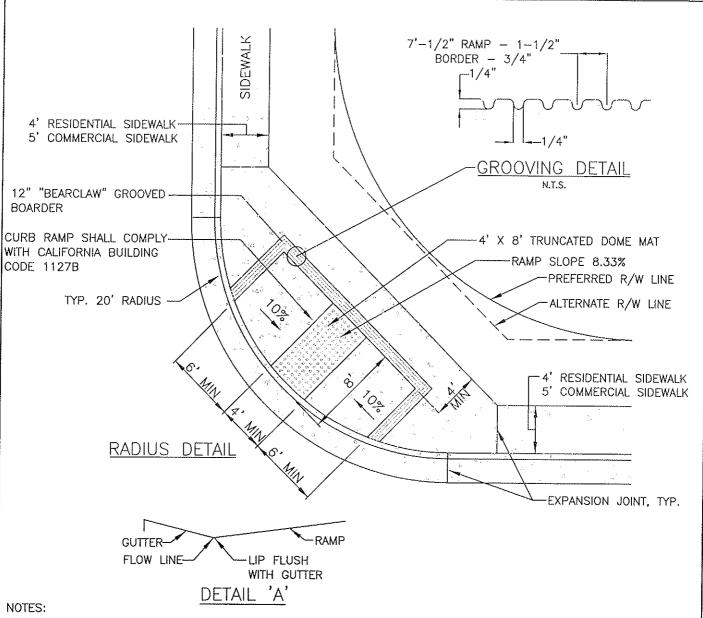

- 1. RAMPS SHALL HAVE NO ABRUPT CHANGES IN ELEVATION OR ANGLE OF SLOPE.
- 2. THE LOWER END OF EACH CURB RAMP SHALL BE FLUSH WITH THE GUTTER (SEE DETAIL "A").
- 3. SIDEWALK AND RAMP THICKNESS SHALL BE 4". COMPACT SUBGRADE TO 95% R.C. MIN.
- 4. RAMP SLOPE SHALL BE 1:12 (8.33%) MAX.
- 5. RAMP SIDE SLOPE SHALL BE 1:10 (10%) MAX. WITH A TRANSVERSE HEAVY BROOM FINISH, SLIP-RESISTANT BROOM FINISH.
- 6. THERE SHALL BE NO SIDEWALK OBSTRUCTIONS. ALL POWER POLES, STREET LIGHTS, FIRE HYDRANTS AND MAIL BOXES SHALL BE SET BACK BEHIND THE SIDEWALK UNLESS APPROVED BY THE CITY ENGINEER.
- 7. IF A LANDING ISN'T PROVIDED, THE FANNED OR FLARED SIDE SLOPE SHOULD BE 1:12 (8.33%) MAX.
- 8. FORMS TO REMAIN FOR A MIN. OF 24 HOURS.
- 9. THERE SHALL BE 0.25' MIN. DROP AROUND A 20' RADIUS.
- 10. CURB RAMPS SHALL HAVE A GROOVED BORDER 12" WIDE DETAILED AS ABOVE.


YCOUNCIL APPROVAL: 2-27-07	CITY OF DINUBA REVISIONS Truncated Dome	DRAWING NO.		4
APPROVED BY CITY ENGINEER			Dwn:	
PROVED BY PUBLIC WORKS DIRECTOR	CITY OF DINUBA Public Improvement Standards	Truncated Dome, WC Ramp	BY T.S.	DATE 4/14/06

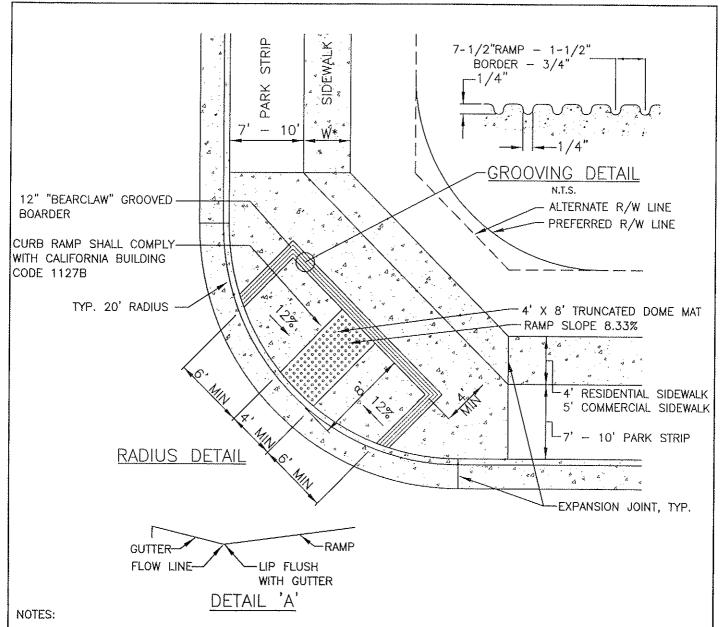


- RAMPS SHALL HAVE NO ABRUPT CHANGES IN ELEVATION OR ANGLE OF SLOPE.
- 2. THE LOWER END OF EACH CURB RAMP SHALL BE FLUSH WITH THE GUTTER (SEE DETAIL "A").
- 3. SIDEWALK AND RAMP THICKNESS SHALL BE 4". COMPACT SUBGRADE TO 95% R.C. MIN.
- 4. RAMP SLOPE SHALL BE 1:12 (8.33%) MAX.
- RAMP SIDE SLOPE SHALL BE 1:10 (10%) MAX. WITH A TRANSVERSE HEAVY BROOM FINISH, SLIP-RESISTANT 5. BROOM FINISH.
- THERE SHALL BE NO SIDEWALK OBSTRUCTIONS. ALL POWER POLES, STREET LIGHTS, FIRE HYDRANTS AND MAIL BOXES SHALL BE SET BACK BEHIND THE SIDEWALK UNLESS APPROVED BY THE CITY ENGINEER.
- IF A LANDING ISN'T PROVIDED, THE FANNED OR FLARED SIDE SLOPE SHOULD BE 1:12 (8.33%) MAX. 7.
- FORMS TO REMAIN FOR A MIN. OF 24 HOURS. 8.
- THERE SHALL BE 0.25' MIN. SLOPE AROUND A 20' RADIUS.
- 10. CURB RAMPS SHALL HAVE A GROOVED BORDER 12" WIDE DETAILED AS ABOVE.

REFER TO 2007 GENERAL PLAN UPDATE.


CITY COUNCIL APPROVAL: 2-27-07	WHEELCHAIR RAMP WITH PARK STRIPS	DRAWING NO.	No. C-4	
APPROVED BY CITY ENGINEER	WITH PARK STRIPS	FILE NAME: C-4a.dwg REVISIONS	Dwn: T BY	Tamez DATE
SEXMM & VITAM	CITY OF DINUBA	Truncated Dome, WC Ramp	T.S.	4/14/06
APPROVED BY PUBLIC WORKS DIRECTOR	Public Improvement Standards	Park Strips	KRG	8/14/06

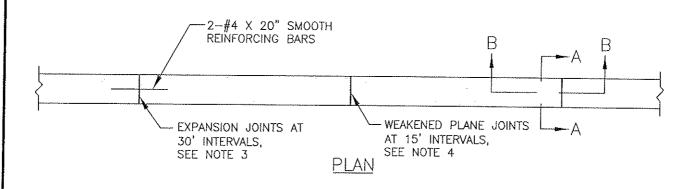


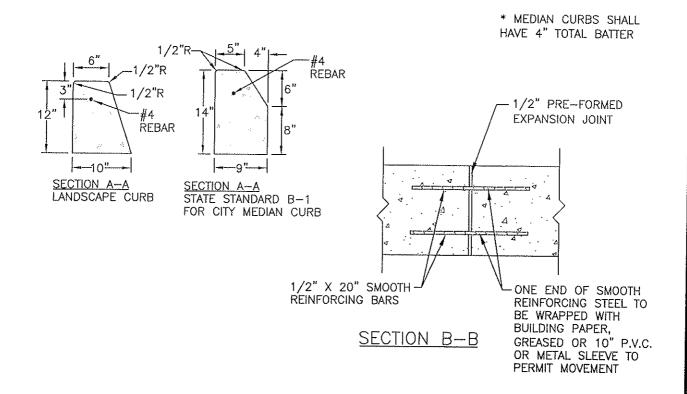

- ALL CONCRETE WORK SHALL BE OF CLASS "A" CONCRETE (6 SACK MIXTURE). ALL CONCRETE SHALL HAVE A LIGHT BROOM FINISH.
- 2.
- EXPANSION JOINTS 1/2" WIDE SHALL BE INSTALLED IN CURB AT 30' INTERVALS, EXPANSION JOINTS FILLED SHALL BE SHAPED TO THE CROSS SECTION OF THE CURB, JOINTS SHALL BE CONSTRUCTED AT 3. RIGHT ANGLES TO BACK OF CURB.
- WEAKENED PLANE JOINTS SHALL BE CONSTRUCTED AT 15' ON CENTER AND SHALL BE A MINIMUM DEPTH OF 1-1/2 TO 2" AND SHALL BE FINISHED WITH A SCORING TOOL LEAVING THE EDGES ROUNDED. MEDIAN CURBS SHALL BE 6 SACK CONCRETE.
- 5.

CITY COUNCIL APPROVAL: 2-27-07		DRAWING NO.	<u> </u>	5
APPROVED BY CITY SNGINEER	LANDSCAPE CURB	FILE NAME: C-5.dwg		Lubong
Lance Detran	CITY OF DINUBA	REVISIONS Notes	T.S.	DATE 4/14/06
APPROVED BY PUBLIC WORKS DIRECTOR	Public Improvement Standards			

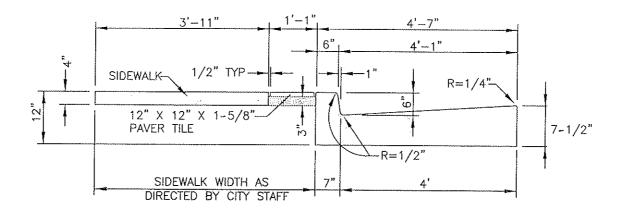

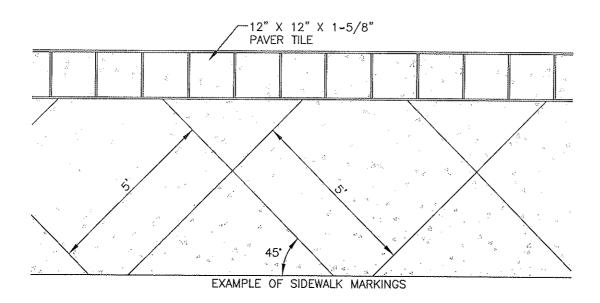



- ALL DECORATIVE CURB, GUTTER AND SIDEWALK SHALL BE CLASS "A" CONCRETE (6 SACK MIN.) COLOR: SAN DIEGO BUFF, DAVIS BRAND COLOR, BUILDERS CONCRETE BATCH NO. NK60170.

 MARKINGS ARE 5' X 5', SALT WITH MEDIUM BROOM FINISH. SQUARE MARKINGS TO BE AT 45' ANGLES. PAVER TILE COLOR: STEP STONE, CLASSIC WALKS, CUSTOM COLOR NO. 1144, FORM FINISH. SEE CONCRETE NOTES AND CITY STD. SPECIFICATIONS.
- 2. 3.

- PAVER MORTAR COLOR: NATURAL COLOR


CITY COUNCIL APPROVAL: 2-27-07	DECORATIVE CURB, GUTTER	DRAWING NO.	C-6
APPROVED BY CITY ENGINEER	AND SIDEWALK	FILE NAME: C-6.dw	g Dwn: C.Tamez BY DATE
Anna Shettin	CITY OF DINUBA	1127101010	DI DAIE
APPROVED BY PUBLIC WORKS DIRECTOR	Public Improvement Standards		

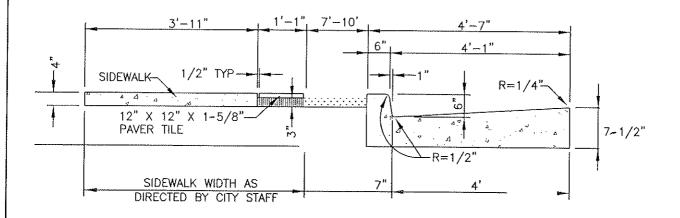

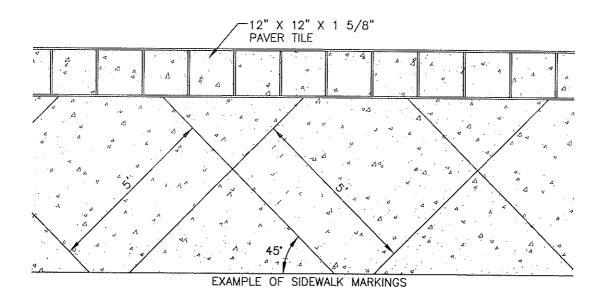


- ALL CONCRETE SHALL BE CLASS "A" CONCRETE (6 SACK MIN.) COLOR: SAN DIEGO BUFF, DAVIS BRAND COLOR, BUILDERS CONCRETE BATCH NO. NK60170.
- MARKINGS ARE 5' X 5', SALT WITH MEDIUM BROOM FINISH. SQUARE MARKINGS TO BE AT 45' ANGLES. PAVER TILE COLOR: STEP STONE, CLASSIC WALKS, CUSTOM COLOR NO. 1144, FORM FINISH. SEE CONCRETE NOTES AND CITY STD. SPECIFICATIONS. PAVER MORTAR COLOR: NATURAL COLOR 2. 3.
- 4.

CITY COUNCIL APPROVAL: 2-27-07	DECORATIVE CURB, GUTTER AND		-6a
APPROVED BY CITY ENGINEER	SIDEWALK WITH PARK STRIPS	FILE NAME: C-6a.dwg REVISIONS	Dwn: C.Tamez
Lanca Dutran	CITY OF DINUBA Public Improvement Standards	Park Strips	BY DATE S.S. 12/15/06
APPROVED BY PUBLIC WORKS DIRECTOR	T done improvement standards		

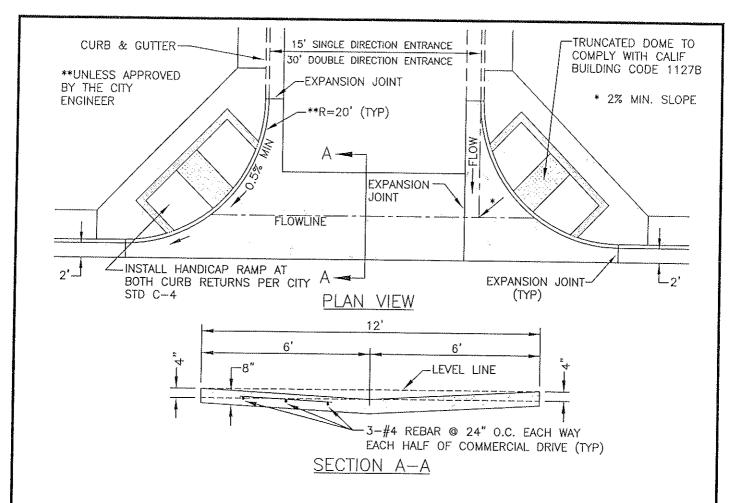


- 1. ALL WORK SHALL CONFORM TO THE APPLICABLE SECTIONS OF THE SPECIFICATIONS ENTITLED "STANDARD SPECIFICATIONS, STATE OF CALIFORNIA, DEPARTMENT OF TRANSPORTATION", APPROVED CURRENT EDITION.
- 2. SUBGRADE PREPARATION FOR CROSS GUTTER SHALL CONFORM TO THE REQUIREMENTS OF THE STANDARD SPECIFICATIONS.
- 3. CONCRETE FOR CROSS GUTTER SHALL BE CLASS "A" (6 SACK MIN.) AND SHALL CONFORM TO THE REQUIREMENTS OF THE STANDARD SPECS.
- 4. EXPANSION JOINTS SHALL BE CONSTRUCTED AT EVERY 30' OR AS DIRECTED BY THE CITY ENGINEER.
- 5. FOR STD. HANDICAP RAMP DIMENSIONS AND NOTES, SEE CITY STD. C-4 OR AS DIRECTED BY THE CITY ENGINEER.
- 6. CONCRETE FOR GUTTER SHALL BE WITHIN 2.5" TO 4.5" SLUMP.
- 7. CONCRETE SHALL CONTAIN NO ADMIXTURES UNLESS PRIOR APPROVAL IS OBTAINED FROM THE CITY ENGINEER.
- 8. CONCRETE SHALL BE CURED WITH A WHITE PIGMENTED CURING COMPOUND COMPLYING TO SECTION 90-7.01B OF THE STANDARD SPECIFICATIONS.
- 9. AN ENCROACHMENT PERMIT IS REQUIRED FOR ALL WORK DONE WITHIN THE CITY OF DINUBA RIGHT OF WAY.
- 10. BEARING SOIL SHALL BE COMPACTED TO 95% RELATIVE COMPACTION AS DETERMINED BY A.S.T.M. D-1557 TO A DEPTH OF 1.0' BELOW CROSS GUTTER AND 1.0' TO EACH SIDE OF THE CROSS GUTTER.
- 11. THE MINIMUM SLOPE ON ALL CROSS GUTTERS IS 0.4% UNLESS APPROVED BY THE CITY ENGINEER.
- 12. ALL CROSS GUTTER LOCATIONS AND SIZES ARE TO BE APPROVED BY THE CITY ENGINEER.

CITY COUNCIL APPROVAL: 2-27-07	STANDARD COMMERCIAL	DRAWING NO.) - '	7
APPROVED BY CITY ENGINEER	DRIVE APPROACH	FILE NAME: C-7,dwg	~	r. Simpson
DARRA KVITTALS	CITY OF DINUBA	REVISIONS Gen Notes	BY T.S.	DATE 4/14/06
APPROVED BY PUBLIC WORKS DIRECTOR	Public Improvement Standards			171400

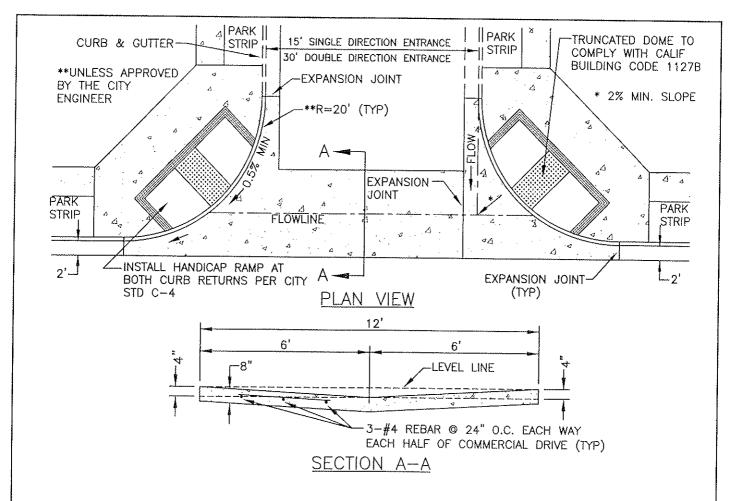

- 1. ALL WORK SHALL CONFORM TO THE APPLICABLE SECTIONS OF THE SPECIFICATIONS ENTITLED "STANDARD SPECIFICATIONS, STATE OF CALIFORNIA, DEPARTMENT OF TRANSPORTATION", APPROVED CURRENT EDITION.
- 2. SUBGRADE PREPARATION FOR CROSS GUTTER SHALL CONFORM TO THE REQUIREMENTS OF THE STANDARD SPECIFICATIONS.
- 3. CONCRETE FOR CROSS GUTTER SHALL BE CLASS "A" (6 SACK MIN.) AND SHALL CONFORM TO THE REQUIREMENTS OF THE STANDARD SPECS.
- 4. EXPANSION JOINTS SHALL BE CONSTRUCTED AT EVERY 30' OR AS DIRECTED BY THE CITY ENGINEER.
- 5. FOR STD. HANDICAP RAMP DIMENSIONS AND NOTES, SEE CITY STD. C-4 OR AS DIRECTED BY THE CITY ENGINEER.
- 6. CONCRETE FOR GUTTER SHALL BE WITHIN 2.5" TO 4.5" SLUMP.
- 7. CONCRETE SHALL CONTAIN NO ADMIXTURES UNLESS PRIOR APPROVAL IS OBTAINED FROM THE CITY ENGINEER.
- 8. CONCRETE SHALL BE CURED WITH A WHITE PIGMENTED CURING COMPOUND COMPLYING TO SECTION 90-7.01B OF THE STANDARD SPECIFICATIONS.
- 9. AN ENCROACHMENT PERMIT IS REQUIRED FOR ALL WORK DONE WITHIN THE CITY OF DINUBA RIGHT OF WAY.
- 10. BEARING SOIL SHALL BE COMPACTED TO 95% RELATIVE COMPACTION AS DETERMINED BY A.S.T.M. D-1557 TO A DEPTH OF 1.0' BELOW CROSS GUTTER AND 1.0' TO EACH SIDE OF THE CROSS GUTTER.
- 11. THE MINIMUM SLOPE ON ALL CROSS GUTTERS IS 0.4% UNLESS APPROVED BY THE CITY ENGINEER.
- 12. ALL CROSS GUTTER LOCATIONS AND SIZES ARE TO BE APPROVED BY THE CITY ENGINEER.

REVISIONS BY DATI		CITY COUNCIL APPROVAL: 2-27-07	STANDARD COMMERCIAL DRIVE	DRAWING NO. C-	-7	a
	1	APPROVED BY CITY ENGINEER	APPROACH WITH PARK STRIPS SHOWN			
CITY OF DINUBA Gen Notes T.S. 4/14/0		DAMAA SOLITAA	CITY OF DINUBA		1	
APPROVED BY PUBLIC WORKS DIRECTOR Public Improvement Standards Park Strips KRG 8/14/0	Ĺ	APPROVED BY PUBLIC WORKS DIRECTOR	Public Improvement Standards	Park Strips	KRG	3/14/06

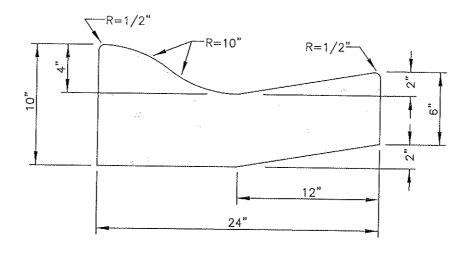


ROLL TYPE CURB AND GUTTER (PLANNED UNIT DEVELOPMENTS ONLY)

- 1. ALL WORK SHALL CONFORM TO THE APPLICABLE SECTIONS OF THE "STANDARD SPECIFICATIONS, STATE OF CALIFORNIA, DEPARTMENT OF TRANSPORTATION", APPROVED CURRENT EDITION, AND THE FOLLOWING GENERAL NOTES:
- 2. SUBGRADE PREPARATION FOR ROLL TYPE CURBS AND GUTTERS SHALL BE CONSTRUCTED TRUE TO GRADE AND CROSS SECTION WITH COMPACTION OF 95% TO A DEPTH OF 6" BELOW THE SUBGRADE.
- 3. CONCRETE FOR CURB AND GUTTER SHALL BE CLASS "A" CONCRETE (6 SACK MIN) AND SHALL BE WITHIN 2.5" TO 5.5" SLUMP.
- 4. TIMBER FORMS SHALL BE SURFACED ON THE SIDE PLACED NEXT TO THE CONCRETE AND SHALL NOT BE LESS THAN 1.5" THICK AFTER BEING SURFACED.
- 5. TOP AND FACE SHALL BE TROWELED SMOOTH, THE GIVEN A FINAL MEDIUM BRUSH FINISH.
- 6. WHERE EXISTING CURB AND GUTTERS ARE TO BE REPLACED, NEW CONSTRUCTION SHALL MATCH EXISTING CONSTRUCTION UNLESS OTHERWISE DIRECTED BY THE CITY ENGINEER.
- 7. CONCRETE SHALL CONTAIN NO ADDITIVES UNLESS PRIOR APPROVAL IS OBTAINED FROM THE CITY ENGINEER.
- 8. CONCRETE SHALL BE CURED WITH A WHITE PIGMENTED CURING COMPOUND COMPLYING TO SECTION 90-7.01B OF THE STANDARD SPECIFICATIONS.
- EXISTING SECTIONS OF CURB AND GUTTER SHALL BE SAWCUT AT THE LIMITS OF THE AREA TO BE RECONSTRUCTED.
- 10. WEAKENED PLANE JOINTS OR COLD JOINTS SHALL BE CONSTRUCTED AT 15' INTERVALS. EXPANSION JOINTS SHALL BE AT EACH SIDE OF STRUCTURES AND AT ENDS OF CURB RETURNS.
- 11. ROLL TYPE CURB AND GUTTER SHALL BE APPROVED BY THE CITY PRIOR TO PERMIT ISSUANCE.
- 12. PERMIT FOR CURB AND GUTTER CONSTRUCTION SHALL ACCOMPANY ACTUAL WORK.
- 13. WHEN CONSTRUCTING NEW CURB AND GUTTER, THE EXISTING PAVEMENT SHALL BE SAWCUT A MINIMUM OF 2.0' FROM THE LIP OF THE GUTTER OR AS DIRECTED BY THE CITY ENGINEER.

Alm K. Ust	ROLL TYPE CURB & GUTTER	DRAWING NO.	C-8
APPROVED BY CITY ENGINEER		FILE NAME: C-8.dwg	Dwn: T. Simpson
(D) anna (do 1110		REVISIONS	BY DATE
KANINA KIDHANA	CITY OF DINUBA		
APPROVED BY PUBLIC WORKS DIRECTOR	Public Improvement Standards		


* FOR SINGLE GARAGES OR CARPORTS THE APPROACH MAY BE REDUCED IN WIDTH UPON APPROVAL BY THE CITY

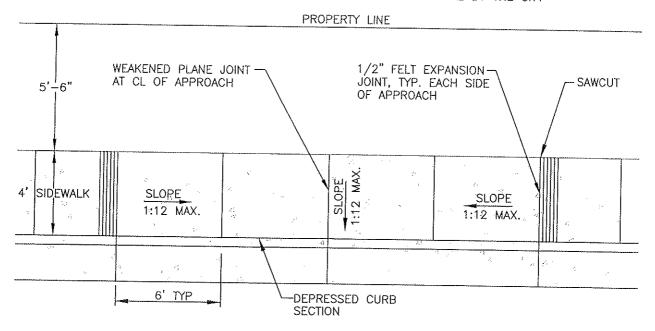

- 1. ENTIRE WIDTH OF DRIVE APRON TO PL SHALL HAVE A MIN. THICKNESS OF 6" OF CONCRETE.
- 2. DRIVE OPENINGS SHALL BE A MIN. OF 24' APART WHEN LOCATED ON THE SAME PROPERTY. NOT MORE THAN 40% OF THE BUILDING SITE FRONTAGE SHALL BE USED FOR VEHICULAR ACCESS.
- 3. THERE SHALL BE 25' MIN. SETBACK FROM STREET INTERSECTION PL TO DRIVE APPROACH. THIS DISTANCE MAY BE INCREASED AT THE DISCRETION OF THE CITY ENGINEER.
- 4. ALL CONCRETE SHALL BE CLASS "B" (5 SACK MINIMUM) AND TEST TO A MIN. OF 2,500 P.S.I. IN 28 DAYS.
- 5. DRIVEWAYS SHALL BE FORMED TO FULL DEPTH OF POUR. WOOD FORMS SHALL HAVE A NOMINAL THICKNESS OF 2". FORMS TO REMAIN FOR A MIN. OF 24 HOURS.
- 6. ALL SIDEWALKS SHALL HAVE A MIN. SLOPE OF 1/4" PER FOOT. COMPACTION SHALL BE 90% R.C. MIN.
- 7. SUBGRADE UNDER DRIVEWAY APPROACH SHALL BE COMPACTED TO 95% R.C. MIN.
- 8. THE DRIVEWAY SURFACE SHALL HAVE A HEAVY BROOM FINISH.
- 9. THE BOTTOM FRONT LIP OF THE DRIVEWAY ENTRANCE SHALL HAVE A 45 DEG. BEVEL.
- 10. A 12" WIDE GROOVED BORDER OF "X" X "X" WIDE AND "X" APART SHALL BE LOCATED ON THE LEVEL SIDEWALK SURFACE AT THE TOP OF THE DRIVEWAY.
- 11. WHERE CURB AND GUTTER IS EXISTING, IT SHALL BE SAWCUT AND REMOVED WITHIN THE LIMITS OF THE DRIVEWAY.


CITY COUNCIL APPROVAL: 2-27-07 ADM K. With-	RESIDENTIAL DRIVE APPROACH	DRAWING NO.	C-9
ARPROVED BY CITY ENGINEER		FILE NAME: C-9.dwg	Dwn: Tamez
XXXXXXXXXXXXXXXXXXXXXXXXXXXXXXXXXXXXXX	CITY OF DINUBA	REVISIONS	BY DATE
APPROVED BY PUBLIC WORKS DIRECTOR	Public Improvement Standards	Gen Notes, Dims	T.S. 4/14/06
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* FOR SINGLE GARAGES OR CARPORTS THE APPROACH MAY BE REDUCED IN WIDTH UPON APPROVAL BY THE CITY

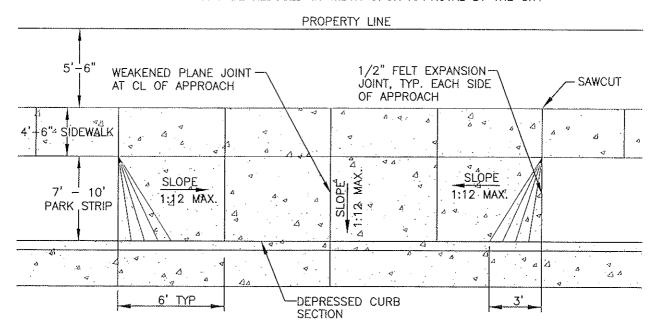


- 1. ENTIRE WIDTH OF DRIVE APRON TO PL SHALL HAVE A MIN. THICKNESS OF 6" OF CONCRETE.
- DRIVE OPENINGS SHALL BE A MIN. OF 24' APART WHEN LOCATED ON THE SAME PROPERTY. NOT MORE THAN 40% OF THE BUILDING SITE FRONTAGE SHALL BE USED FOR VEHICULAR ACCESS.
- 3. THERE SHALL BE 25' MIN. SETBACK FROM STREET INTERSECTION PL TO DRIVE APPROACH. THIS DISTANCE MAY BE INCREASED AT THE DISCRETION OF THE CITY ENGINEER.
- 4. ALL CONCRETE SHALL BE CLASS "B" (5 SACK MINIMUM) AND TEST TO A MIN. OF 2,500 P.S.I. IN 28 DAYS.
- 5. DRIVEWAYS SHALL BE FORMED TO FULL DEPTH OF POUR. WOOD FORMS SHALL HAVE A NOMINAL THICKNESS OF 2". FORMS TO REMAIN FOR A MIN. OF 24 HOURS.
- 6. ALL SIDEWALKS SHALL HAVE A MIN. SLOPE OF 1/4" PER FOOT. COMPACTION SHALL BE 90% R.C. MIN.
- 7. SUBGRADE UNDER DRIVEWAY APPROACH SHALL BE COMPACTED TO 95% R.C. MIN.
- 8. THE DRIVEWAY SURFACE SHALL HAVE A HEAVY BROOM FINISH.
- THE BOTTOM FRONT LIP OF THE DRIVEWAY ENTRANCE SHALL HAVE A 45 DEG. BEVEL.
- WHERE CURB AND GUTTER IS EXISTING, IT SHALL BE SAWCUT AND REMOVED WITHIN THE LIMITS OF THE DRIVEWAY.
- 11. REFER TO 2007 GENERAL PLAN UPDATE.

CITY COUNCIL APPROVAL: 2-27-07	RESIDENTIAL DRIVE APPROACH	DRAWING NO.	-9a
APPROVED BY CITY ENGINEER	WITH PARK STRIPS	FILE NAME: C-9a.dwg REVISIONS	Dwn: Tamez BY DATE
WAMAN DO HAM	CITY OF DINUBA	Gen Notes, Dims	T.S. 4/14/06
APPROVED BY PUBLIC WORKS DIRECTOR	Public Improvement Standards	Park Strips	KRG 8/14/06

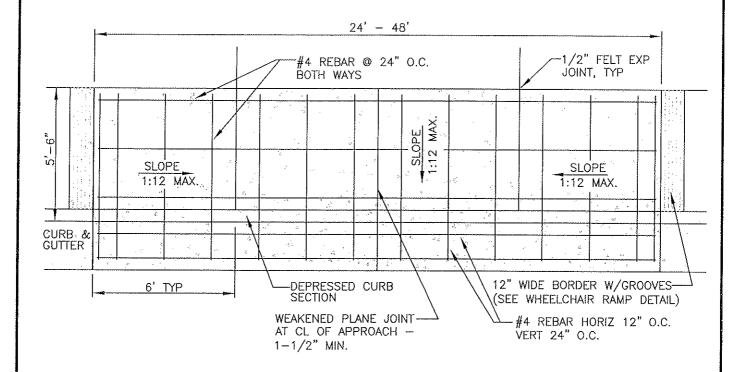


- 1. ENTIRE WIDTH OF DRIVE APRON TO PL SHALL HAVE A MIN. THICKNESS OF 8" OF CONCRETE.
- 2. DRIVE OPENINGS SHALL BE A MIN. OF 24' APART WHEN LOCATED ON THE SAME PROPERTY. NOT MORE THAN 70% OF THE BUILDING SITE FRONTAGE SHALL BE USED FOR VEHICULAR ACCESS.
- THERE SHALL BE 35' MIN. SETBACK FROM CURB AND GUTTER RADIUS END TO DRIVE APPROACH. THIS
 DISTANCE MAY BE INCREASED AT THE DISCRETION OF THE CITY ENGINEER.
- 4. ALL CONCRETE SHALL BE CLASS "A" (6 SACK MINIMUM) AND TEST TO A MIN. OF 3,000 P.S.I. IN 28 DAYS.
- 5. DRIVEWAYS SHALL BE FORMED TO FULL DEPTH OF POUR.
- ALL SIDEWALKS SHALL HAVE A MIN. SLOPE OF 1/4" PER FOOT. COMPACTION SHALL BE 90% R.C. MIN.
- 7. SUBGRADE UNDER DRIVEWAY APPROACH SHALL BE COMPACTED TO 95% R.C. MIN.
- 8. THE DRIVEWAY SURFACE SHALL HAVE A HEAVY BROOM FINISH.
- 9. THE BOTTOM FRONT LIP OF THE DRIVEWAY ENTRANCE SHALL HAVE A 45 DEG. BEVEL.
- 10. A 12" WIDE GROOVED BORDER OF 1/4" X 1/4" WIDE AND 3/4" APART SHALL BE LOCATED ON THE LEVEL SIDEWALK SURFACE AT THE TOP OF THE DRIVEWAY.
- 11. WHERE CURB AND GUTTER IS EXISTING, IT SHALL BE SAWCUT AND REMOVED WITHIN THE LIMITS OF THE DRIVEWAY.


CITY COUNCIL APPROVAL: 2-27-07	COMMERCIAL & INDUSTRIAL	DRAWING NO.	-10
APPROVED BY CITY ENGINEER	DRIVEWAY	FILE NAME: C-10.dwg REVISIONS	Dwn: Tamez BY DATE
APPROVED BY PUBLIC WORKS DIRECTOR	CITY OF DINUBA Public Improvement Standards	Gen Notes, Dims	T.S. 4/14/06

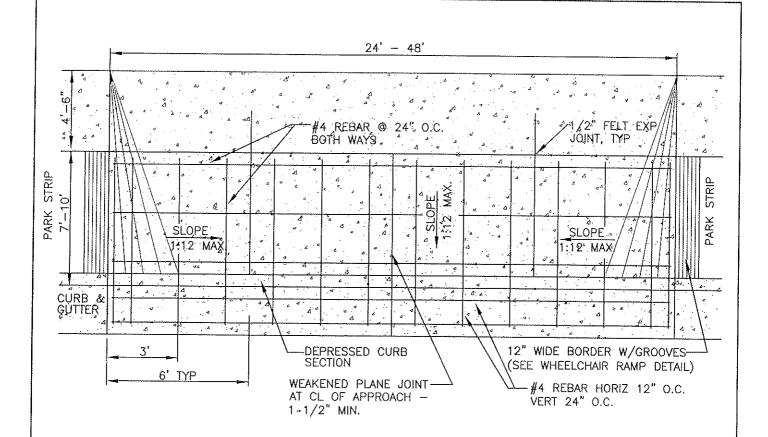


- 1. ENTIRE WIDTH OF DRIVE APRON TO PL SHALL HAVE A MIN. THICKNESS OF 8" OF CONCRETE.
- DRIVE OPENINGS SHALL BE A MIN. OF 24' APART WHEN LOCATED ON THE SAME PROPERTY. NOT MORE THAN 70% OF THE BUILDING SITE FRONTAGE SHALL BE USED FOR VEHICULAR ACCESS.
- 3. THERE SHALL BE 35' MIN. SETBACK FROM CURB AND GUTTER RADIUS END TO DRIVE APPROACH. THIS DISTANCE MAY BE INCREASED AT THE DISCRETION OF THE CITY ENGINEER.
- 4. ALL CONCRETE SHALL BE CLASS "A" (6 SACK MINIMUM) AND TEST TO A MIN. OF 3,000 P.S.I. IN 28 DAYS.
- 5. DRIVEWAYS SHALL BE FORMED TO FULL DEPTH OF POUR.
- 6. ALL SIDEWALKS SHALL HAVE A MIN. SLOPE OF 1/4" PER FOOT. COMPACTION SHALL BE 90% R.C. MIN.
- 7. SUBGRADE UNDER DRIVEWAY APPROACH SHALL BE COMPACTED TO 95% R.C. MIN.
- 8. THE DRIVEWAY SURFACE SHALL HAVE A HEAVY BROOM FINISH.
- 9. THE BOTTOM FRONT LIP OF THE DRIVEWAY ENTRANCE SHALL HAVE A 45 DEG. BEVEL.
- 10. A 12" WIDE GROOVED BORDER OF 14" X 14" WIDE AND 34" APART SHALL BE LOCATED ON THE LEVEL SIDEWALK SURFACE AT THE TOP OF THE DRIVEWAY.
- 11. WHERE CURB AND GUTTER IS EXISTING, IT SHALL BE SAWCUT AND REMOVED WITHIN THE LIMITS OF THE DRIVEWAY.
- 12. REFER TO 2007 GENERAL PLAN UPDATE.

CITY COUNCIL APPROVAL: 2-27-07	COMMERCIAL & INDUSTRIAL	DRAWING NO.	1(Ja
APPROVED BY CITY ENGINEER	DRIVEWAY WITH PARK STRIPS	FILE NAME: C-10a.dwg		Tamez
DAMAS HHALL	CITY OF DINUBA	REVISIONS Gen Notes, Dims	T.S.	DATE 4/14/06
APPROVED BY PUBLIC WORKS DIRECTOR	Public Improvement Standards	PARK STRIPS	S.S.	12/14/06

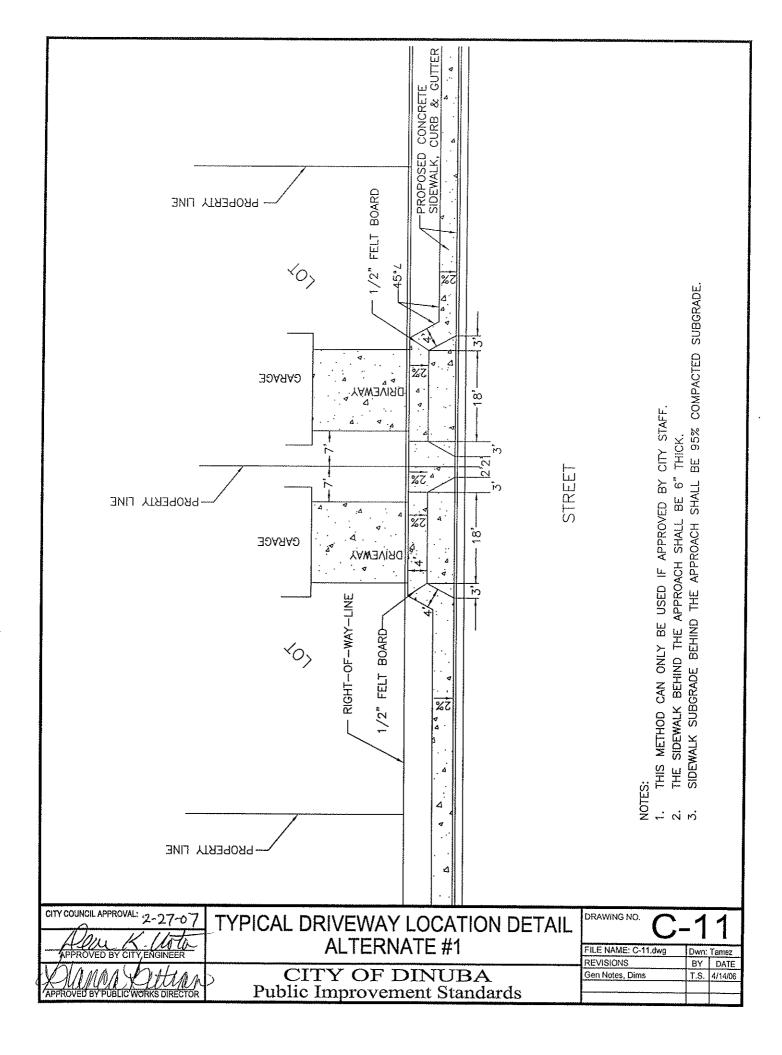


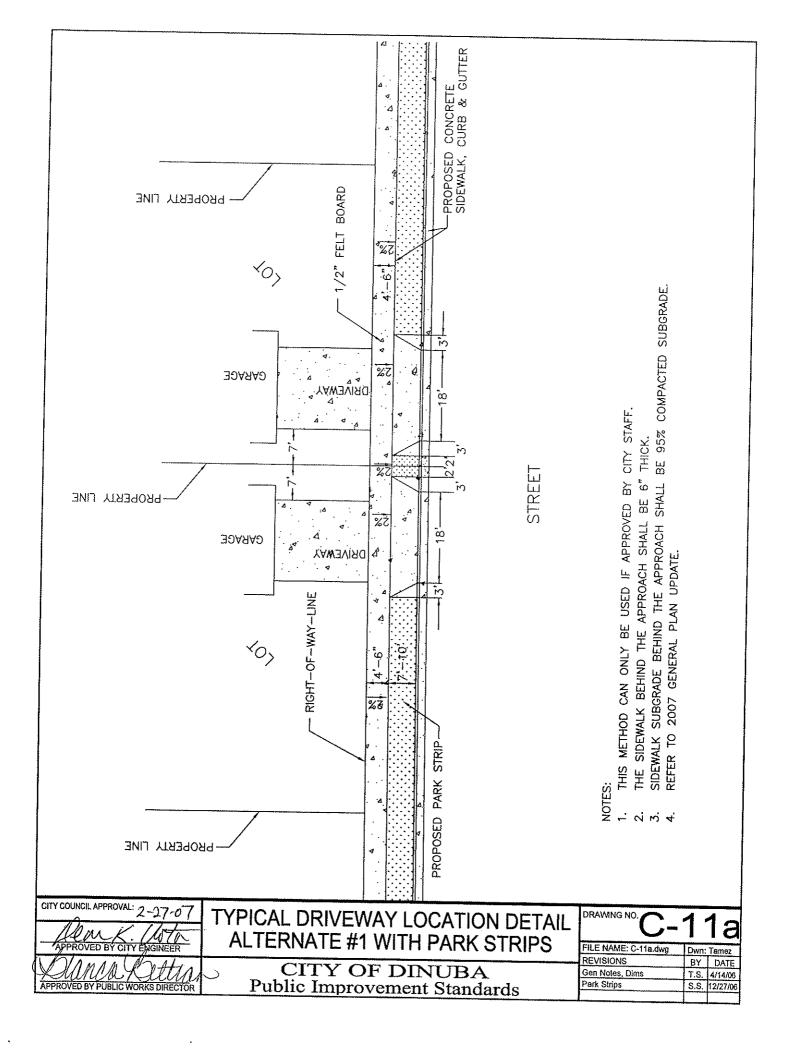

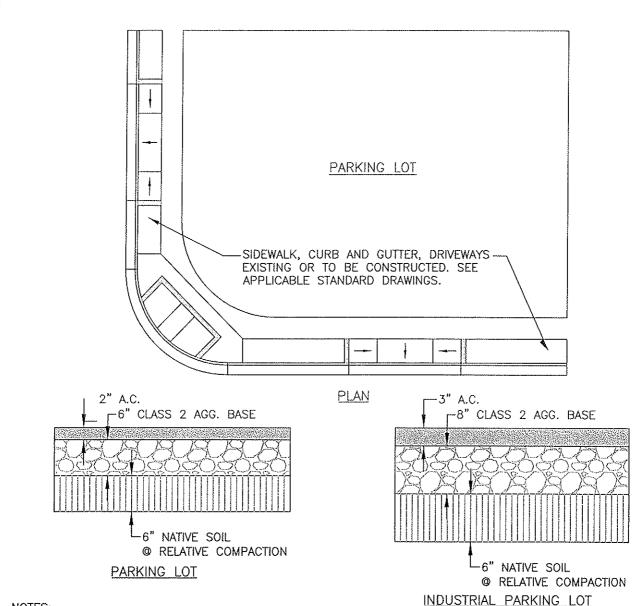

- 1. A COMPLETE DRAINAGE PLAN AND PARKING STALL LAYOUT SHALL BE SUBMITTED TO THE CITY FOR APPROVAL PRIOR TO ANY CONSTRUCTION.
- 2. MINIMUM SLOPE SHALL BE 1% FOR ASPHALT SURFACE AND 0.2% FOR FLOWLINES.
- 3. PROVIDE ADEQUATE DRAINAGE THROUGH APPROVED CATCH BASINS AND PIPES TO THE NEAREST STORM DRAIN SYSTEM. FLOW OVER SIDEWALKS OR LANDSCAPE AREA IS NOT PERMITTED.
- 4. SURFACE DRAINAGE TO ALLEY MAY BE ALLOWED ONLY BY WRITTEN APPROVAL OF THE CITY OF DINUBA.
- 5. WEED KILLER SHALL BE APPLIED IN ACCORDANCE WITH MFGRS. RECOMMENDATIONS, TO BASE ROCK PRIOR TO PAVING.
- 6. THE DESIGN SHALL MAXIMIZE ON-SITE DRAINAGE RETENTION.
- 7. SURFACE DRAINAGE SHALL BE TO APPROVED LOCATIONS.
- 8. PAVEMENT STRUCTURAL SECTION SHALL BE DESIGNED BY A REGISTERED CIVIL ENGINEER BASED UPON THE R-VALUE CALCULATIONS.

CITY COUNCIL APPROVAL: 2-27-07	PARKING LOT REQUIREMENTS	DRAWING NO.	D_ ′	1
APPROVED BY CITY ENGINEER		FILE NAME: P-1,dwg REVISIONS	Dwn: BY	C.Tamez DATE
MIMMA Ketting	CITY OF DINUBA	Gen Notes	 	4/14/06
APPROVED BY PUBLIC WORKS DIRECTOR	Public Improvement Standards			

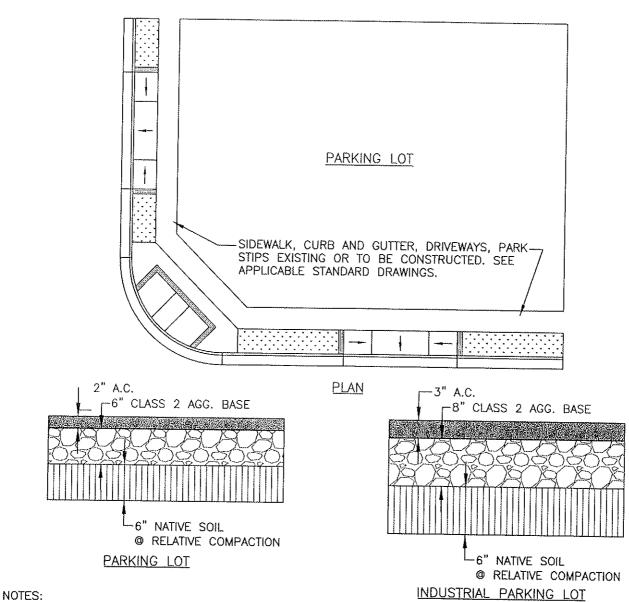


- A COMPLETE DRAINAGE PLAN AND PARKING STALL LAYOUT SHALL BE SUBMITTED TO THE CITY FOR APPROVAL PRIOR TO ANY CONSTRUCTION.
- MINIMUM SLOPE SHALL BE 1% FOR ASPHALT SURFACE AND 0.2% FOR FLOWLINES.
- PROVIDE ADEQUATE DRAINAGE THROUGH APPROVED CATCH BASINS AND PIPES TO THE NEAREST 3. STORM DRAIN SYSTEM. FLOW OVER SIDEWALKS OR LANDSCAPE AREA IS NOT PERMITTED.
- SURFACE DRAINAGE TO ALLEY MAY BE ALLOWED ONLY BY WRITTEN APPROVAL OF THE CITY OF DINUBA.
- WEED KILLER SHALL BE APPLIED IN ACCORDANCE WITH MFGRS. RECOMMENDATIONS, TO BASE 5. ROCK PRIOR TO PAVING.
- 6. THE DESIGN SHALL MAXIMIZE ON-SITE DRAINAGE RETENTION.
- SURFACE DRAINAGE SHALL BE TO APPROVED LOCATIONS. 7.
- PAVEMENT STRUCTURAL SECTION SHALL BE DESIGNED BY A CIVIL ENGINEER BASED UPON THE 8. R-VALUE CALCULATIONS FROM A GEOTECHNICAL ENGINEER.
- REFER TO 2007 GENERAL PLAN UPDATE.

CITY COUNCIL APPROVAL: 2-27-07

PARKING LOT REQUIREMENTS WITH PARK STRIPS SHOWN


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FILE NAME: P-1.dwg	Dwn:	Dwn: C.Tamez		
REVISIONS	BY	DATE		
Gen Notes	T.S.	4/14/06		
Park Strips	S.S.	12/18/06		

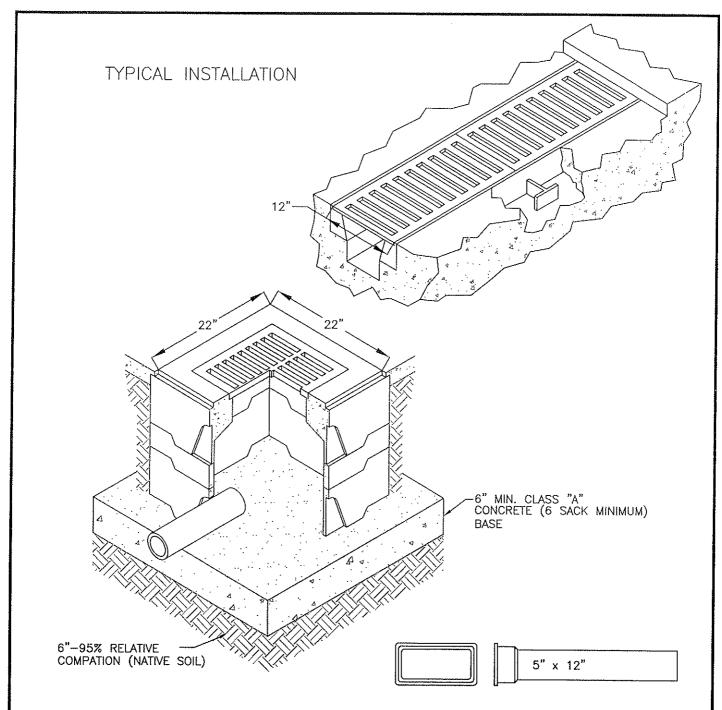


- 1. RECTANGULAR CAST IRON TRENCH GRATE TO BE USED BETWEEN CONCRETE DRIVEWAY AND PARKING LOT PAVEMENT "CHRISTY" TYPE 'U' INLETS AND GRATES
- 2. DRAIN TRENCH UNDER SIDEWALK TO STREET GUTTER MAY BE USED UPON APPROVAL FROM THE DEVELOPMENT SERVICES DEPARTMENT.
- 3. THIS ABOVE TO BE USED ONLY IF UNDERGROUND CITY STORM DRAIN LINE NOT AVAILABLE AND STREET DRAINAGE IS UTILIZED.
- 4. ON-SITE AREA CATCH BASINS WITH NOT LESS THAN 12" DIAMETER STORM DRAIN PIPE MAY BE USED IF EXISTING UNDERGROUND STORM DRAIN IS AVAILABLE. QUIKSET DB1818 'CHRISTY' V-64 REFERENCE ONLY.


	CITY COUNCIL APPROVAL: 2-27-07	PARKING LOT DRAINAGE DETAILS	DRAWING NO.	- 2
	APPROVED BY CITY ENGINEER		FILE NAME: P-2.dwg REVISIONS	Dwn: Tamez
	ELAMAA SE SETTANA	CITY OF DINUBA	Gen Notes, Callouts	BY DATE T.S. 4/14/06
1	APPROVED BY PUBLIC WORKS DIRECTOR	Public Improvement Standards		

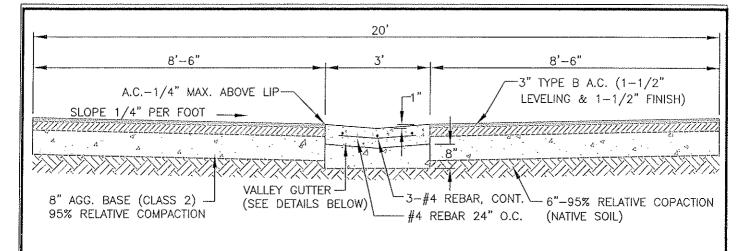

ALLEY CROSS SECTION

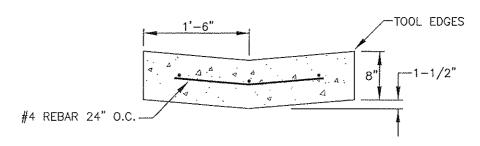


VALLEY GUTTER, END

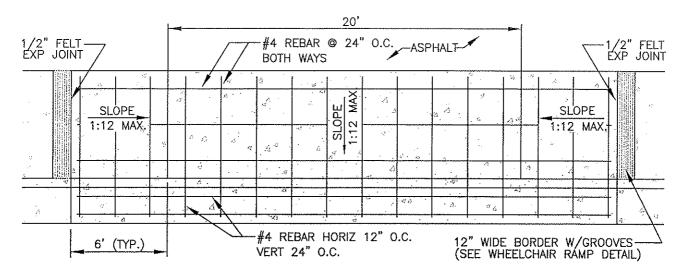


ALLEY APPROACH

- SEE COMMERCIAL AND INDUSTRIAL DRIVEWAY DETAIL AND ALLEY DETAILS FOR ADDITIONAL CONSTRUCTION NOTES.
- CONCRETE SHALL BE TYPE "A" (6 SACK MINIMUM). MINIMUM APPROACH THICKNESS SHALL BE 8 INCHES. 2.


CITY COUNCIL APPROVAL: 2-27-07	COMMERCIAL & RESIDENTIAL	DRAWING NO.	- 3
APPROVED BY CITY ENGINEER	ALLEYS	FILE NAME: P-3.dwg REVISIONS	Dwn: Tamez BY DATE
APPROVED BY PUBLIC WORKS DIRECTOR	CITY OF DINUBA Public Improvement Standards	Callouts	T.S. 4/14/06

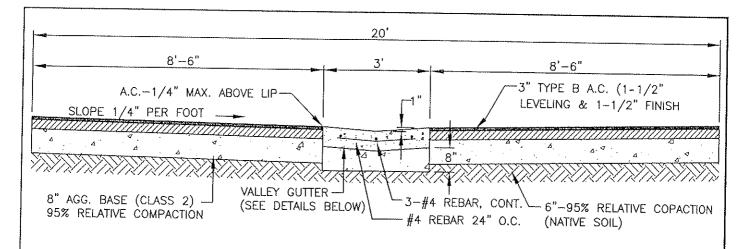

ALLEY CROSS SECTION

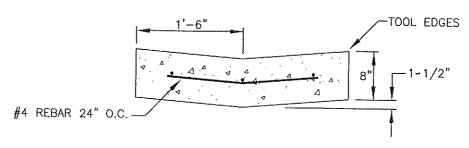


VALLEY GUTTER, END

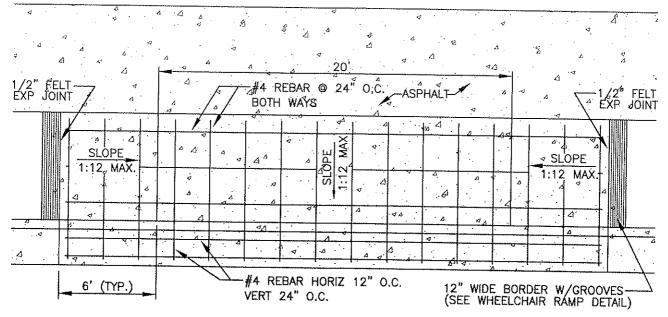


ALLEY APPROACH


- SEE COMMERCIAL AND INDUSTRIAL DRIVEWAY DETAIL AND ALLEY DETAILS FOR ADDITIONAL CONSTRUCTION NOTES.
- CONCRETE SHALL BE TYPE "A" (6 SACK MINIMUM). MINIMUM APPROACH THICKNESS SHALL BE 8 INCHES.


CITY COUNCIL APPROVAL: 2-27-07 APPROVED BY CITY ENGINEER	COMMERCIAL & RESIDENTIAL ALLEYS WITH PARK STRIPS	DRAWING NO. P	-3a
APPROVED BY PUBLIC WORKS DIRECTOR	CITY OF DINUBA Public Improvement Standards	REVISIONS Callouts Park Strips	BY DATE T.S. 4/14/06 S.S. 12/18/06

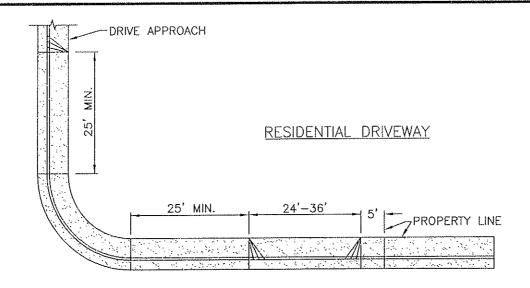


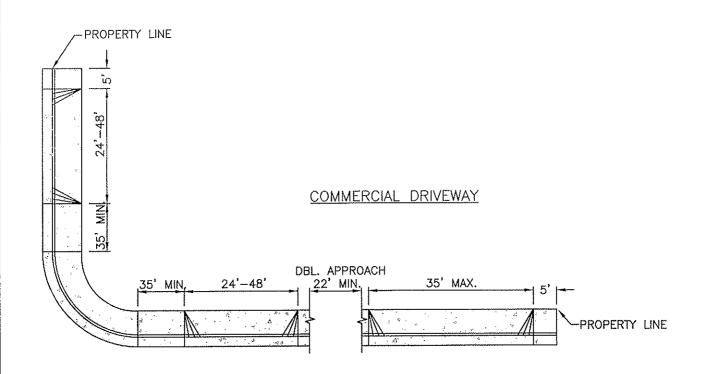

- 1. 22' MINIMUM DISTANCE BETWEEN DOUBLE APPROACH.
- 2. CONCRETE WORK SHALL BE TYPE "A" (5 SACK MINIMUM) RESIDENTIAL AND TYPE "A" (6 SACK MINIMUM) COMMERCIAL/INDUSTRIAL.
- 3. NOT MORE THAN 50% OF FRONTAGE SHALL BE USED AS DRIVE APPROACH.
- 4. EXPANSION JOINTS 1/2" WIDE SHALL BE INSTALLED ON BOTH SIDES OF APPROACH AT RIGHT ANGLES TO BACK OF CURB.

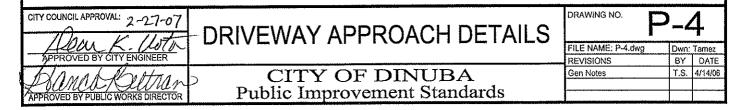


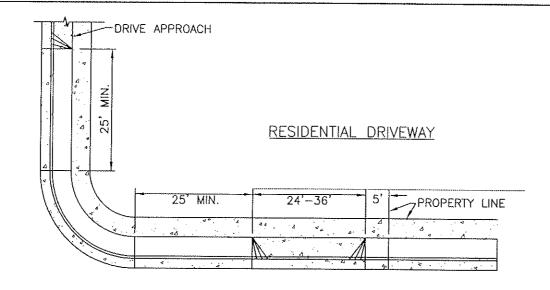

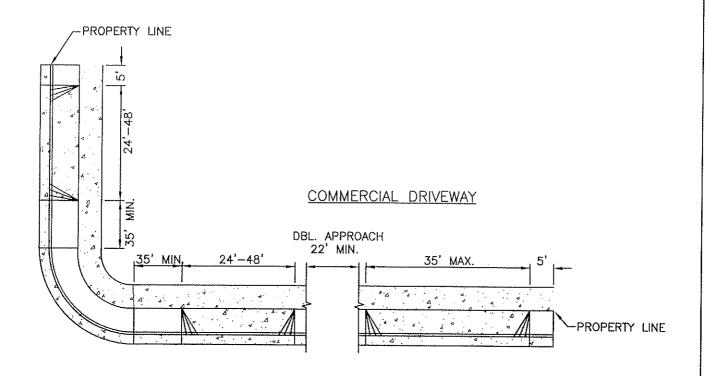

- 1. 22' MINIMUM DISTANCE BETWEEN DOUBLE APPROACH.
- CONCRETE WORK SHALL BE TYPE "A" (5 SACK MINIMUM) RESIDENTIAL AND TYPE "A" (6 SACK MINIMUM) 2. COMMERCIAL/INDUSTRIAL.
 NOT MORE THAN 50% OF FRONTAGE SHALL BE USED AS DRIVE APPROACH.
- 3.
- EXPANSION JOINTS 1/2" WIDE SHALL BE INSTALLED ON BOTH SIDES OF APPROACH AT RIGHT ANGLES TO 4. BACK OF CURB.

CITY COUNCIL APPROVAL: 2-27-07	DRIVEWAY APPROACH DETAILS	DRAWING NO.	-4a
APPROVED BY CITY ENGINEER	WITH PARK STRIPS	FILE NAME: P-4.dwg	Dwn: Tamez
Sana Abutaan	CITY OF DINUBA	REVISIONS Gen Notes	BY DATE T.S. 4/14/06
APPROVED BY PUBLIC WORKS DIRECTOR	Public Improvement Standards	Park Strips	S.S. 12/18/06

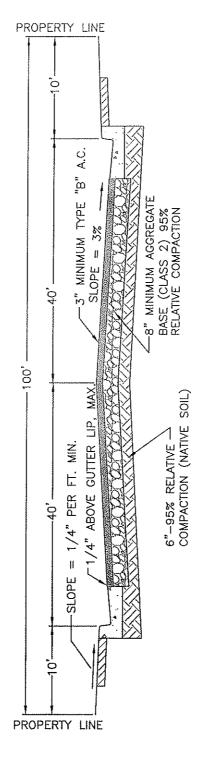


A STREET THAT SERVES A LARGE VOLUME OF VEHICULAR TRAFFIC WITH INTERSECTIONS AT GRADE AND GENERALLY HAVING DIRECT ACCESS TO ABUTTING, PROPERTY, AND ON WHICH GEOMETRIC DESIGN AND TRAFFIC CONTROL MEASURES ARE USED TO EXPEDITE THE SAFE MOVEMENT OF THROUGH TRAFFIC. DEFINITION:

ASPHALT AND AGGREGATE BASE ARE SHOWN AT MIN. REQUIRED DEPTHS, SUBJECT TO R-VALUE AND TRAFFIC INDEX BASED CALCULATIONS BY A REGISTERED CIVIL ENGINEER.
RECYCLED AGGREGATE BASE IS ALLOWED IF CERTIFIED PER CALTRANS STDS. & APPROVED BY CITY STAFF. PROVIDE A CALTRANS CERTIFICATE OF COMPLIANCE FROM SUPPLIER FOR ALL MATERIALS. NOTES:

210

CITY COUNCIL APPROVAL: 2-27-07 APPROVED BY CITY ENGINEER	ARTERIAL STREET (100' R.O.W.)	DRAWING NO. FILE NAME: P-5.dwg REVISIONS	D-5
APPROVED BY PUBLIC WORKS DIRECTOR	CITY OF DINUBA Public Improvement Standards	Gen Notes, 'R' Value	BY DA T.S. 4/14

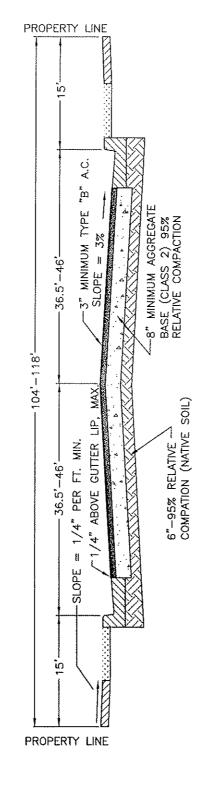

A STREET THAT SERVES A LARGE VOLUME OF VEHICULAR TRAFFIC WITH INTERSECTIONS AT GRADE AND GENERALLY HAVING DIRECT ACCESS TO ABUTTING, PROPERTY, AND ON WHICH GEOMETRIC DESIGN AND TRAFFIC CONTROL MEASURES ARE USED TO EXPEDITE THE SAFE MOVEMENT OF THROUGH TRAFFIC. DEFINITION:

NOTES:


ASPHALT AND AGGREGATE BASE ARE SHOWN AT MIN. REQUIRED DEPTHS, SUBJECT TO R-VALUE BASED CALCULATIONS BY A CIVIL ENGINEER.

RECYCLED AGGREGATE BASE IS ALLOWED IF CERTIFIED PER CALTRANS STDS. & APPROVED BY CITY STAFF. PROVIDE A CALTRANS CERTIFICATE OF COMPLIANCE FROM SUPPLIER FOR ALL MATERIALS.

R-VALUE AND PAVEMENT CALCULATIONS SHALL BE SUBMITTED TO THE CITY OF DINUBA BY A 9KH

GEOTECHNICAL ENGINEER. REFER TO 2007 GENERAL PLAN UPDATE. ഗ

CITY COUNCIL APPROVAL: 2-27-07	ARTERIAL STREET WITH		-58	a
APPROVED BY CITY ENGINEER	PARK STRIPS	FILE NAME: P-5a,dwg REVISIONS	Dwn: Ta	mez DATE
Hum Settian	CITY OF DINUBA	Gen Notes, 'R' Value Park Strips	T.S. 4/	/14/06
APPROVED BY PUBLIC WORKS DIRECTOR	Public Improvement Standards	Park Strips	S.S. 12	722/06

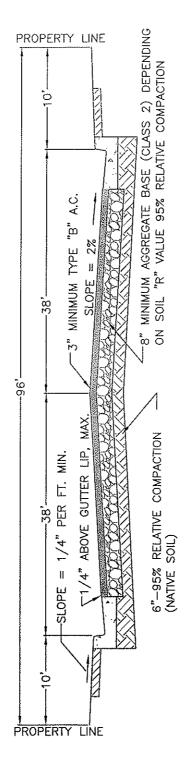


NOTES:

ASPHALT AND AGGREGATE BASE ARE SHOWN AT MIN. REQUIRED DEPTHS, SUBJECT TO R-VALUE AND TRAFFIC INDEX BASED CALCULATIONS BY A REGISTERED CIVIL ENGINEER.

RECYCLED AGGREGATE BASE IS ALLOWED IF CERTIFIED PER CALTRANS STDS. & APPROVED BY CITY STAFF. PROVIDE A CALTRANS CERTIFICATE OF COMPLIANCE FROM SUPPLIER FOR ALL MATERIALS. 25

CITY COUNCIL APPROVAL: 2-27-07	ARTERIAL STREET (96' R.O.W.)	DRAWING NO.	P-6
APPROVED BY CITY ENGINEER		FILE NAME: P-6.dwg REVISIONS	Dwn: Tamez BY DATE
APPROVED BY PUBLIC WORKS DIRECTOR	CITY OF DINUBA Public Improvement Standards	Gen Notes, 'R' Value	T.S. 4/14/06

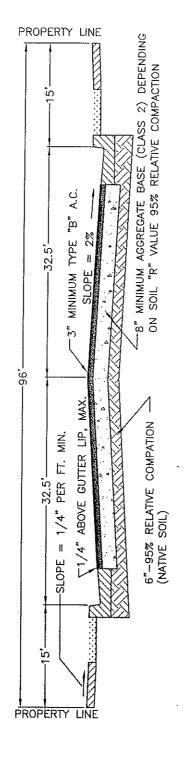

NOTES:

ASPHALT AND AGGREGATE BASE ARE SHOWN AT MIN. REQUIRED DEPTHS, SUBJECT TO R-VALUE BASED

CALCULATIONS BY A CIVIL ENGINEER.

RECYCLED AGGREGATE BASE IS ALLOWED IF CERTIFIED PER CALTRANS STDS. & APPROVED BY CITY STAFF.

PROVIDE A CALTRANS CERTIFICATE OF COMPLIANCE FROM SUPPLIER FOR ALL MATERIALS.

R-VALUE AND PAVEMENT CALCULATIONS SHALL BE SUBMITTED TO THE CITY OF DINUBA BY A GEOTECHNICAL ENGINEER.

REFER TO 2007 GENERAL PLAN UPDATE. 9 m 4


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LA	PPROVED	BY PUBL	C WORK	S DIREC	TOR

ARTERIAL STREET (96' R.O.W.) WITH PARK STRIPS

CITY OF DINUBA Public Improvement Standards

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FILE NAME: P-6a.dwg	Dwn:	Tamez
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Gen Notes, 'R' Value	T.S.	4/14/05
Park Strips	S.S.	12/22/06

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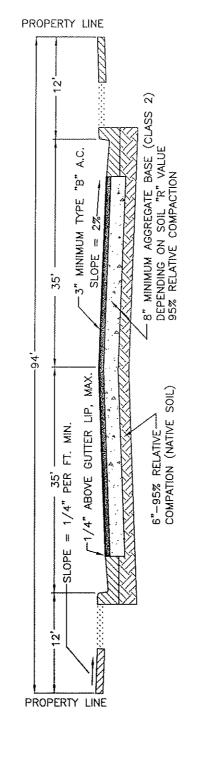


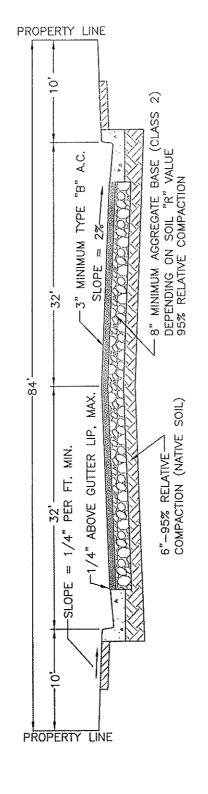NOTES:

ASPHALT AND AGGREGATE BASE ARE SHOWN AT MIN. REQUIRED DEPTHS, SUBJECT TO R-VALUE AND TRAFFIC INDEX BASED CALCULATIONS BY A REGISTERED CIVIL ENGINEER.

RECYCLED AGGREGATE BASE IS ALLOWED IF CERTIFIED PER CALTRANS STDS. & APPROVED BY CITY STAFF. PROVIDE A CALTRANS CERTIFICATE OF COMPLIANCE FROM SUPPLIER FOR ALL MATERIALS. 210

CITY COUNCIL APPROVAL: 2-27-07 APPROVED BY CITY ENGINEER	MAJOR COLLECTOR STREET (84' R.O.W.)	DRAWING NO. File NAME: P-7.dwg REVISIONS	Dwn: Tamez BY DATE
DAMA SULTAN- APPROVED BY PUBLIC WORKS DIRECTOR	> CITY OF DINUBA Public Improvement Standards	Gen Notes, 'R' Value	T.S. 4/14/06



NOTES:

ASPHALT AND AGGREGATE BASE ARE SHOWN AT MIN. REQUIRED DEPTHS, SUBJECT TO R-VALUE BASED

CALCULATIONS BY A CIVIL ENGINEER.

RECYCLED AGGREGATE BASE IS ALLOWED IF CERTIFIED PER CALTRANS STDS. & APPROVED BY CITY STAFF. PROVIDE A CALTRANS CERTIFICATE OF COMPLIANCE FROM SUPPLIER FOR ALL MATERIALS.

R-VALUE AND PAVEMENT CALCULATIONS SHALL BE SUMITTED TO THE CITY OF DINUBA BY A GEOTECHNICAL ENGINEER.


REFER TO 2007 GENERAL PLAN UPDATE. 9K 4

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CITY COUNCIL APPROVAL 2 -27-0 APPROVED BY CITY ENGINEE PROVED BY PUBLIC WORKS DIRECTOR

MAJOR COLLECTOR STREET (94' R.O.W.) WITH PARK STRIPS


DRAWING NO.	P.	-7	a
FILE NAME: P-76	a.dwg	Dwn:	Tamez
REVISIONS		₿Y	DATE
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Park Strips		S.S.	12/22/06

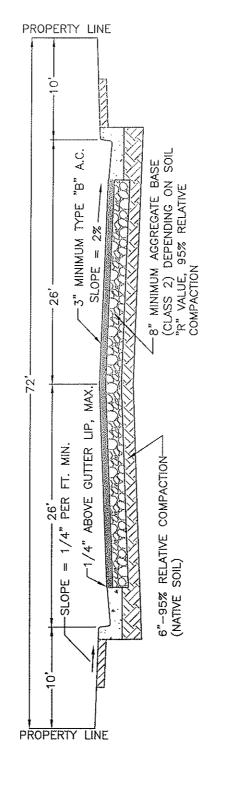

NOTES:

ASPHALT AND AGGREGATE BASE ARE SHOWN AT MIN. REQUIRED DEPTHS, SUBJECT TO R-VALUE AND TRAFFIC INDEX BASED CALCULATIONS BY A REGISTERED CIVIL ENGINEER.
RECYCLED AGGREGATE BASE IS ALLOWED IF CERTIFIED PER CALTRANS STDS. & APPROVED BY CITY STAFF. PROVIDE A CALTRANS CERTIFICATE OF COMPLIANCE FROM SUPPLIER FOR ALL MATERIALS.
MAX. LENGTH 990' WITHOUT INTERVENING STREET, MIN. LENGTH 660'. 9 kg 4

ı	CITY COUNCIL APPROVAL: 2-27-07	MINOR COLLECTOR STREET	DRAWING NO.	2 -8
	APPROVED BY CITY ENGINEER	(72' R.O.W.)	FILE NAME: P-8.dwg	Dwn: Tamez BY DATE
1	Ganca Butta	CITY OF DINUBA	Gen Notes, 'R' Value	T.S. 4/14/06
1	APPROVED BY PUBLIC WORKS DIRECTOR	Public Improvement Standards		

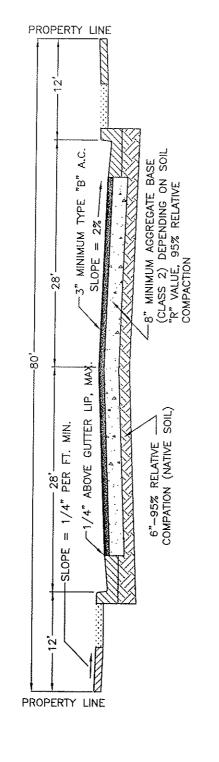

NOTES:

ASPHALT AND AGGREGATE BASE ARE SHOWN AT MIN. REQUIRED DEPTHS, SUBJECT TO R-VALUE BASED CALCULATIONS BY A CIVIL ENGINEER.

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R-VALUE AND PAVEMENT CALCULATIONS SHALL BE SUBMITTED TO THE CITY OF DINUBA BY A GEOTECHNICAL ENGINEER.

REFER TO 2007 GENERAL PLAN UPDATE.


CITY STAFF.

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CITY COUNCIL APPROVAL: ENGINEER PPROVED BY PUBLIC WORKS DIRECTOR

MINOR COLLECTOR STREET (80' R.O.W.) WITH PARK STRIPS

DRAWING NO.	P.	-8	a
FILE NAME: P-8a	.dwg	Dwn:	Tamez
REVISIONS		BY	DATE
Gen Notes, 'R' Va	lue	T.S.	4/14/06
Park Strips		S.S.	12/22/06
		1	

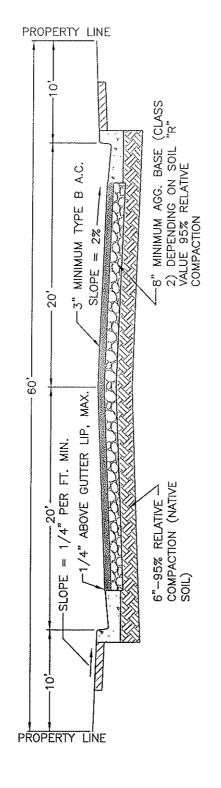

DEFINITION; A STREET THAT SERVES THE LOCAL NEEDS OF RESIDENTIAL PROPERTIES IN A NEIGHBORHOOD.

NOTES:

ASPHALT AND AGGREGATE BASE ARE SHOWN AT MIN. REQUIRED DEPTHS, SUBJECT TO R-VALUE AND TRAFFIC INDEX BASED CALCULATIONS BY A REGISTERED CIVIL ENGINEER.


RECYCLED AGGREGATE BASE IS ALLOWED IF CERTIFIED PER CALTRANS STDS. & APPROVED BY CITY STAFF. PROVIDE A CALTRANS CERTIFICATE OF COMPLIANCE FROM SUPPLIER FOR ALL MATERIALS.

MAX. LENGTH 990' WITHOUT INTERVENING STREET, MIN. LENGTH 660'. 9 m 4

	CITY COUNCIL APPROVAL: 2-27-07	Γ
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	Bruns Gertin	
-	APPROVED BY PUBLIC WORKS DIRECTOR	_

LOCAL COLLECTOR STREET (60' R.O.W.)

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FILE NAME: P-9.dwg	Dwn:	Tamez
REVISIONS	BY	DATE
Gen Notes, 'R' Value	T.S.	4/14/06

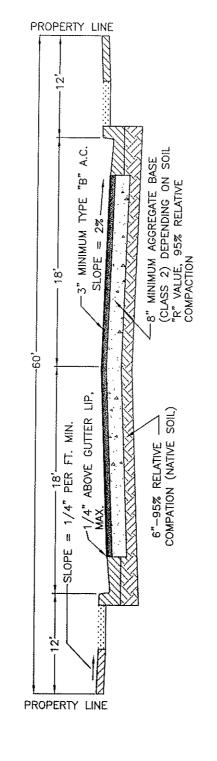

DEFINITION: A STREET THAT SERVES THE LOCAL NEEDS OF RESIDENTIAL PROPERTIES IN A NEIGHBORHOOD.

NOTES

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R-VALUE AND PAVEMENT CALCULATIONS SHALL BE SUMITTED TO THE CITY OF DINUBA BY A GEOTECHNICAL ENGINEER.

REFER TO 2007 GENERAL PLAN UPDATE.


CITY STAFF.

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	CITY COUNCIL APPROVAL: 2-27-07
	APPROVED BY CITY ENGINEER
1	Donna Potta
1	APPROVED BY PUBLIC WORKS DIRECTOR

LOCAL COLLECTOR STREET (60' R.O.W.) WITH PARK STRIPS

DRAWING NO.	-9	a
FILE NAME: P-9a.dwg	Dwn:	Tamez
REVISIONS	BY	DATE
Gen Notes, 'R' Value	T.S.	4/14/06
Park Strips	S.S.	12/27/06

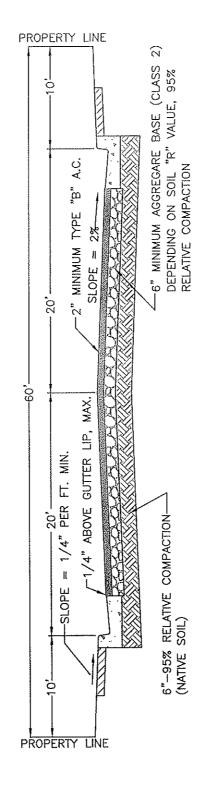

DEFINITION: A STREET THAT SERVES THE LOCAL NEEDS OF RESIDENTIAL PROPERTIES IN A NEIGHBORHOOD.


NOTES:

CITY STAFF. ASPHALT AND AGGREGATE BASE ARE SHOWN AT MIN. REQUIRED DEPTHS, SUBJECT TO R-VALUE AND TRAFFIC INDEX BASED CALCULATIONS BY A REGISTERED CIVIL ENGINEER.

RECYCLED AGGREGATE BASE IS ALLOWED IF CERTIFIED PER CALTRANS STDS. & APPROVED BY CITY S PROVIDE A CALTRANS CERTIFICATE OF COMPLIANCE FROM SUPPLIER FOR ALL MATERIALS.

MAX. LENGTH 990' WITHOUT INTERVENING STREET, MIN. LENGTH 660'. 9 m 4

CITY COUNCIL APPROVAL: 2-27-07 ACM K. Custa LOCAL STREET (60' R.O.W.) APPROVED BY CITY ENGINEER		DRAWING NO. P-10		
		FILE NAME: P-10.dwg REVISIONS	Dwn: T BY	Tamez DATE
AMMA BUTTON APPROVED BY PUBLIC WORKS DIRECTOR	CITY OF DINUBA Public Improvement Standards	Gen Notes, 'R' Value	T.S.	4/14/06

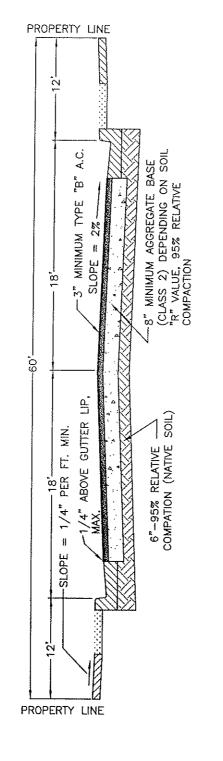

DEFINITION: A STREET THAT SERVES THE LOCAL NEEDS OF RESIDENTIAL PROPERTIES IN A NEIGHBORHOOD.

NOTES:

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CALCULATIONS BY A CIVIL ENGINEER.

RECYCLED AGGREGATE BASE IS ALLOWED IF CERTIFIED PER CALTRANS STDS. & APPROVED BY CITY STAFF. PROVIDE A CALTRANS CERTIFICATE OF COMPLIANCE FROM SUPPLIER FOR ALL MATERIALS.

MAX. LENGTH 990' WITHOUT INTERVENING STREET, MIN. LENGTH 660'.

R—VALUE AND PAVEMENT CALCULATIONS SHALL BE SUBMITTED TO THE CITY OF DINUBA BY A GEOTECHNICAL ENGINEER.


REFER TO 2007 GENERAL PLAN UPDATE. 94.4°

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CITY COUNCIL APPROVAL:

CAL STREET (60' R.O.W.) WITH PARK STRIPS

	DRAWING NO. P_1		Ja
	FILE NAME: P-10a.dwg	Dwn:	Tamez
-	REVISIONS	BY	DATE
-	Gen Notes, 'R' Value	T.S.	4/14/06
-	Park Strips	S.S.	12/27/06

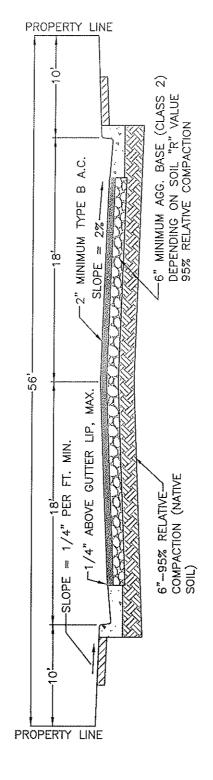



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412

CITY COUNCIL APPROVAL: DRAWING NO. -27-0 LOCAL STREET (56' R.O.W.) FILE NAME: P-11.dwg Dwn: Tamez REVISIONS BY DATE APPROVED BY PUBLIC WORKS DIRECTOR CITY OF DINUBA Gen Notes, 'R' Value T.S. 4/14/06 Public Improvement Standards



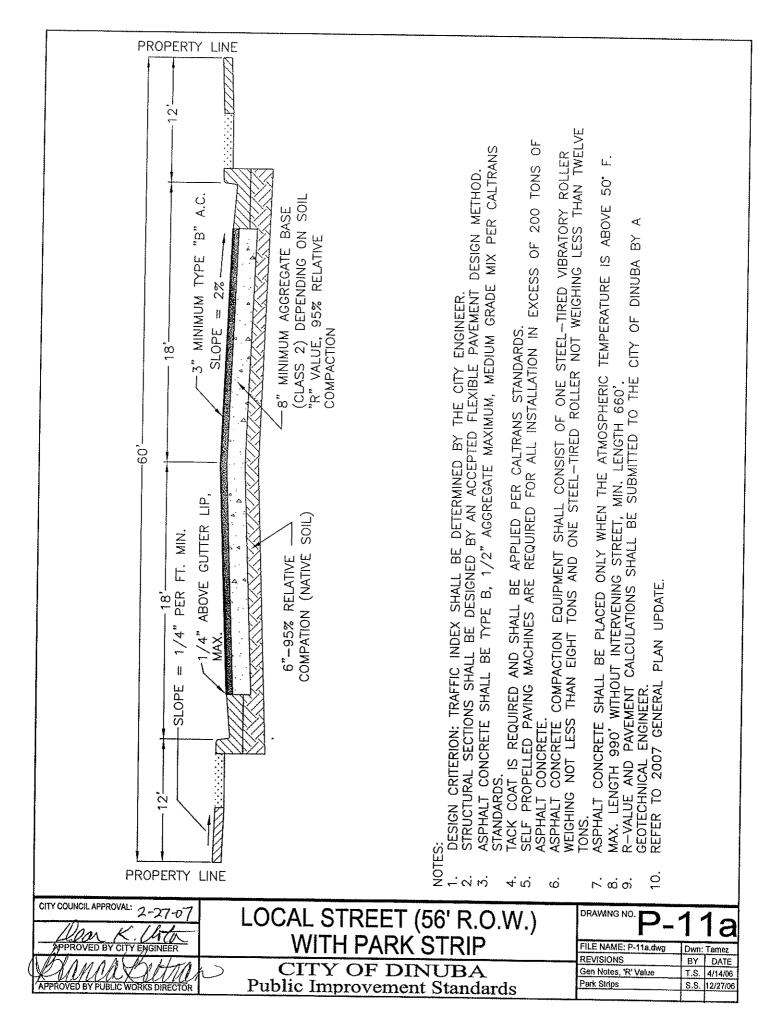


ASPHALT AND AGGREGATE BASE ARE SHOWN AT MIN. REQUIRED DEPTHS, SUBJECT TO R-VALUE BASED 1. CALCULATIONS BY A REGISTERED CIVIL ENGINEER.

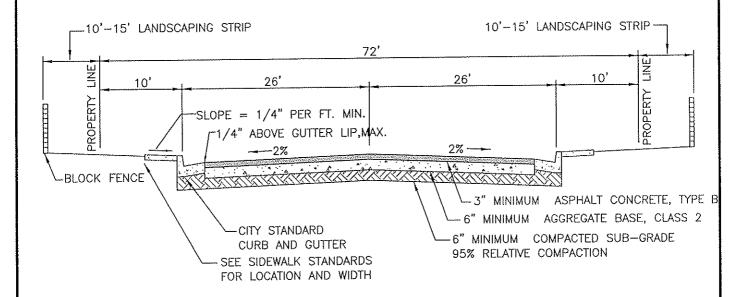RECYCLED AGGREGATE BASE IS ALLOWED IF CERTIFIED PER CALTRANS STDS. & APPROVED BY CITY STAFF.

PROVIDE A CALTRANS CERTIFICATE OF COMPLIANCE FROM SUPPLIER FOR ALL MATERIALS. 3.


MAX. LENGTH 990' WITHOUT INTERVENING STREET, MIN. LENGTH 660'.

CITY COUNCIL APPROVAL: 2-27-07	COLLECTOR WITH	DRAWING NO.	-12
APPROVED BY CITY ENGINEER	LANDSCAPE EASEMENT	FILE NAME: P-12.dwg REVISIONS	Dwn: T. Simpson BY DATE
ADPROVED BY PUBLIC WORKS DIRECTOR	CITY OF DINUBA Public Improvement Standards		

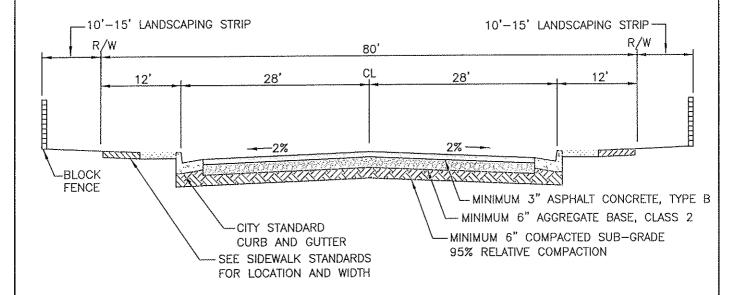


- DESIGN CRITERION: TRAFFIC INDEX SHALL BE DETERMINED BY THE CITY ENGINEER. STRUCTURAL SECTIONS SHALL BE DESIGNED BY AN ACCEPTED FLEXIBLE PAVEMENT DESIGN METHOD. 2.
- ASPHALT CONCRETE SHALL BE TYPE B, 1/2" AGGREGATE MAXIMUM, MEDIUM GRADE MIX PER CALTRANS 3. STANDARDS.
- TACK COAT IS REQUIRED AND SHALL BE APPLIED PER CALTRANS STANDARDS.
- SELF PROPELLED PAVING MACHINES ARE REQUIRED FOR ALL INSTALLATION IN EXCESS OF 200 TONS OF 5. ASPHALT CONCRETE.
- ASPHALT CONCRETE COMPACTION EQUIPMENT SHALL CONSIST OF ONE STEEL-TIRED VIBRATORY ROLLER WEIGHING NOT LESS THAN EIGHT TONS AND ONE STEEL-TIRED ROLLER NOT WEIGHING LESS THAN TWELVE 6. TONS.
- ASPHALT CONCRETE SHALL BE PLACED ONLY WHEN THE ATMOSPHERIC TEMPERATURE IS ABOVE 50' F. 7.

	CITY COUNCIL APPROVAL: 2-27-07	COLLECTOR WITH LANDSCAPE	DRAWING NO. P_	12	2a
	APPROVED BY CITY ENGINEER	EASEMENT AND PARK STRIPS	FILE NAME: P-12a.dwg REVISIONS	Đwn: T BY	f. Simpson DATE
	Sana Oltin	CITY OF DINUBA	Park Strip		12/27/06
)	APPROVED BY PUBLIC WORKS DIRECTOR	Public Improvement Standards			

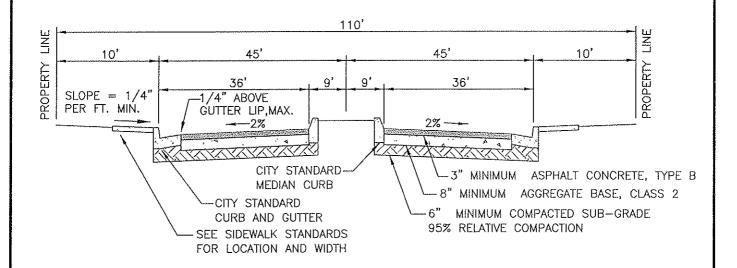


- ASPHALT AND AGGREGATE BASE ARE SHOWN AT MIN. REQUIRED DEPTHS, SUBJECT TO R-VALUE BASED CALCULATIONS BY A REGISTERED CIVIL ENGINEER.
- 2. RECYCLED AGGREGATE BASE IS ALLOWED IF CERTIFIED PER CALTRANS STDS. & APPROVED BY CITY STAFF.
- 3. PROVIDE A CALTRANS CERTIFICATE OF COMPLIANCE FROM SUPPLIER FOR ALL MATERIALS.

ŀ	CITY COUNCIL APPROVAL: 2-2-7-07	MAJOR ARTERIAL WITH MEDIAN	DRAWING NO.	-13	3
ı	APPROVED BY CITY ENGINEER		FILE NAME: P-13.dwg REVISIONS	Dwn: T. Sim	mpson ATE
	DUM XXIIIA APPROVED BY PUBLIC WORKS DIRECTOR	CITY OF DINUBA Public Improvement Standards			

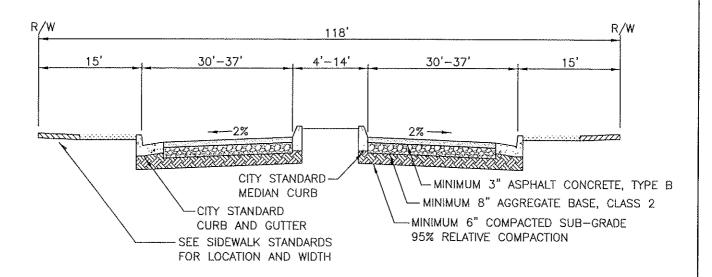


- 1. DESIGN CRITERION: TRAFFIC INDEX SHALL BE DETERMINED BY THE CITY ENGINEER.
- 2. STRUCTURAL SECTIONS SHALL BE DESIGNED BY AN ACCEPTED FLEXIBLE PAVEMENT DESIGN METHOD.
- 3. ASPHALT CONCRETE SHALL BE TYPE B, 3/4" AGGREGATE MAXIMUM, MEDIUM GRADE MIX PER CALTRANS STANDARDS.
- 4. TACK COAT IS REQUIRED AND SHALL BE APPLIED PER CALTRANS STANDARDS.
- 5. SELF PROPELLED PAVING MACHINES ARE REQUIRED FOR ALL INSTALLATION IN EXCESS OF 200 TONS OF SPHALT CONCRETE.
- 6. ASPHALT CONCRETE COMPACTION EQUIPMENT SHALL CONSIST OF ONE STEEL—TIRED VIBRATORY ROLLER W EIIGHING NOT LESS THAN EIGHT TONS AND ONE STEEL—TIRED ROLLER NOT WEIGHING LESS THAN TWELVE TONS.
- 7. ASPHALT CONCRETE SHALL BE PLACED ONLY WHEN THE ATMOSPHERIC TEMPERATURE IS ABOVE 50° F.
- 8. WITH ADDITIONAL LANDSCAPE EASEMENTS, SIDEWALK MAY BE LOCATED OUTSIDE 110' RIGHT OF WAY TO PROVIDE ADDITIONAL PARKWAY.
- 9. REFER TO 2007 GENERAL PLAN UPDATE.

APPROVED BY CITY ENGINEER CITY OF DINUBA REVISIONS BY DATE Park Strips S.S. 12/27/06	CITY COUNCIL APPROVAL: 2-27-	MAJOR ARTERIAL WITH MEDIAN	DRAWING NO. P_	13a
CITY OF DINUBA Park Strips S.S. 12/27/06	APPROVED BY CITY ENGINEE	WITH PARK STRIPS		Dwn: T. Simpson
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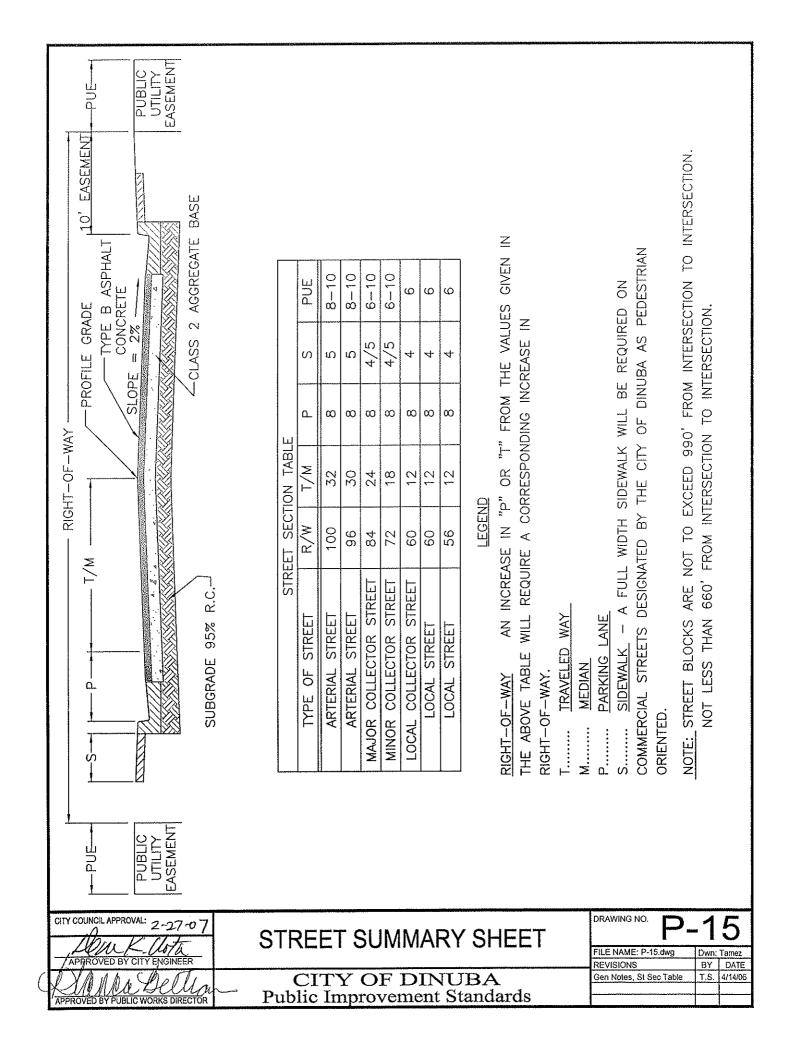
- ASPHALT AND AGGREGATE BASE ARE SHOWN AT MIN. REQUIRED DEPTHS, SUBJECT TO R-VALUE BASED CALCULATIONS BY A REGISTERED CIVIL ENGINEER.
- RECYCLED AGGREGATE BASE IS ALLOWED IF CERTIFIED PER CALTRANS STDS. & APPROVED BY CITY STAFF. PROVIDE A CALTRANS CERTIFICATE OF COMPLIANCE FROM SUPPLIER FOR ALL MATERIALS. 2.
- 3.
- MAX. LENGTH 990' WITHOUT INTERVENING STREET, MIN. LENGTH 660'.

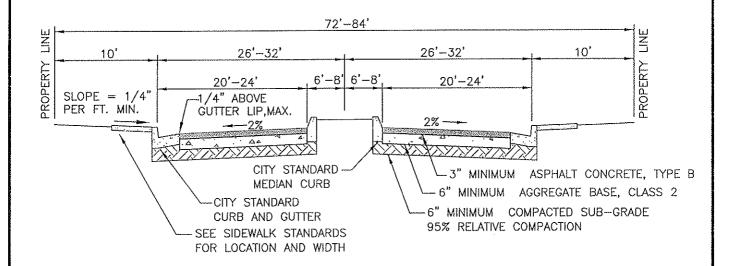
	CITY COUNCIL APPROVAL: 2-27-07	MINOR COLLECTOR WITH MEDIAN		-14
1	APPROVED BY CITY ENGINEER		FILE NAME: P-14.dwg REVISIONS	Dwn: T. Simpson BY DATE
(APPROVED BY PUBLIC WORKS DIRECTOR	CITY OF DINUBA Public Improvement Standards		





- DESIGN CRITERION: TRAFFIC INDEX SHALL BE DETERMINED BY THE CITY ENGINEER. 1.
- STRUCTURAL SECTIONS SHALL BE DESIGNED BY AN ACCEPTED FLEXIBLE PAVEMENT DESIGN METHOD.
- ASPHALT CONCRETE SHALL BE TYPE B, &" AGGREGATE MAXIMUM, MEDIUM GRADE MIX PER CALTRANS 3. STANDARDS.
- TACK COAT IS REQUIRED AND SHALL BE APPLIED PER CALTRANS STANDARDS.
 SELF PROPELLED PAVING MACHINES ARE REQUIRED FOR ALL INSTALLATION IN EXCESS OF 200 TONS OF 5. ASPHALT CONCRETE.
- ASPHALT CONCRETE COMPACTION EQUIPMENT SHALL CONSIST OF ONE STEEL-TIRED VIBRATORY ROLLER WEIGHING NOT LESS THAN EIGHT TONS AND ONE STEEL-TIRED ROLLER NOT WEIGHING LESS THAN TWELVE
- ASPHALT CONCRETE SHALL BE PLACED ONLY WHEN THE ATMOSPHERIC TEMPERATURE IS ABOVE 50° F. 7.
- WITH ADDITIONAL LANDSCAPE EASEMENTS, SIDEWALK MAY BE LOCATED OUTSIDE 72'-84" RIGHT OF WAY 8. TO PROVIDE ADDITIONAL PARKWAY.
- REFER TO 2007 GENERAL PLAN UPDATE.

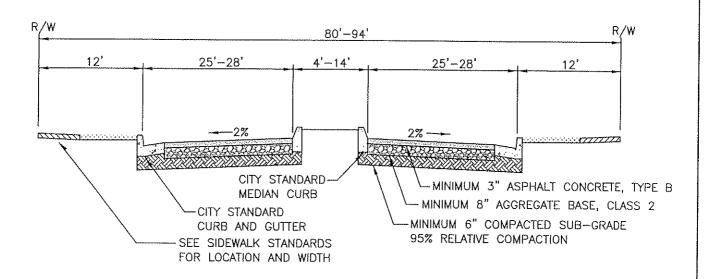COLLECTOR WITH MEDIAN	DRAWING NO. P	14a
WITH PARK STRIPS	FILE NAME: P-14a.dwg REVISIONS	Dwn: T. Simpson BY DATE
APPROVED BY PUBLIC WORKS DIRECTOR Public Improvement Standards	Park Strips	BY DATE S.S. 12/27/06




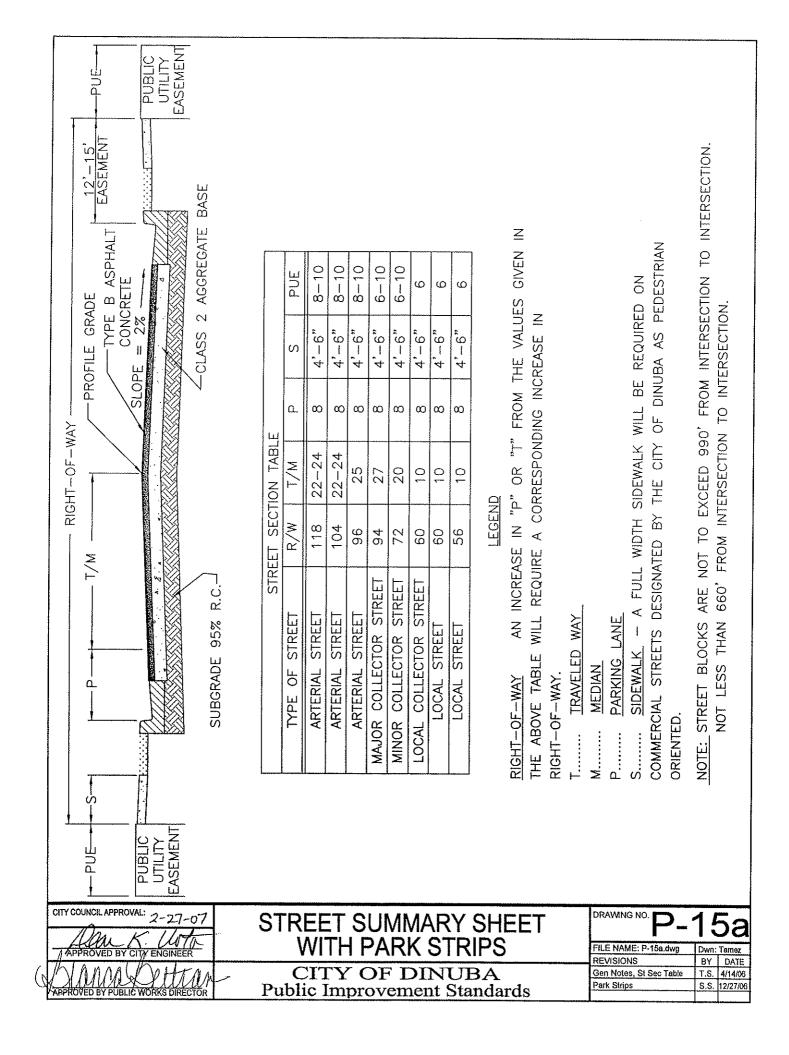

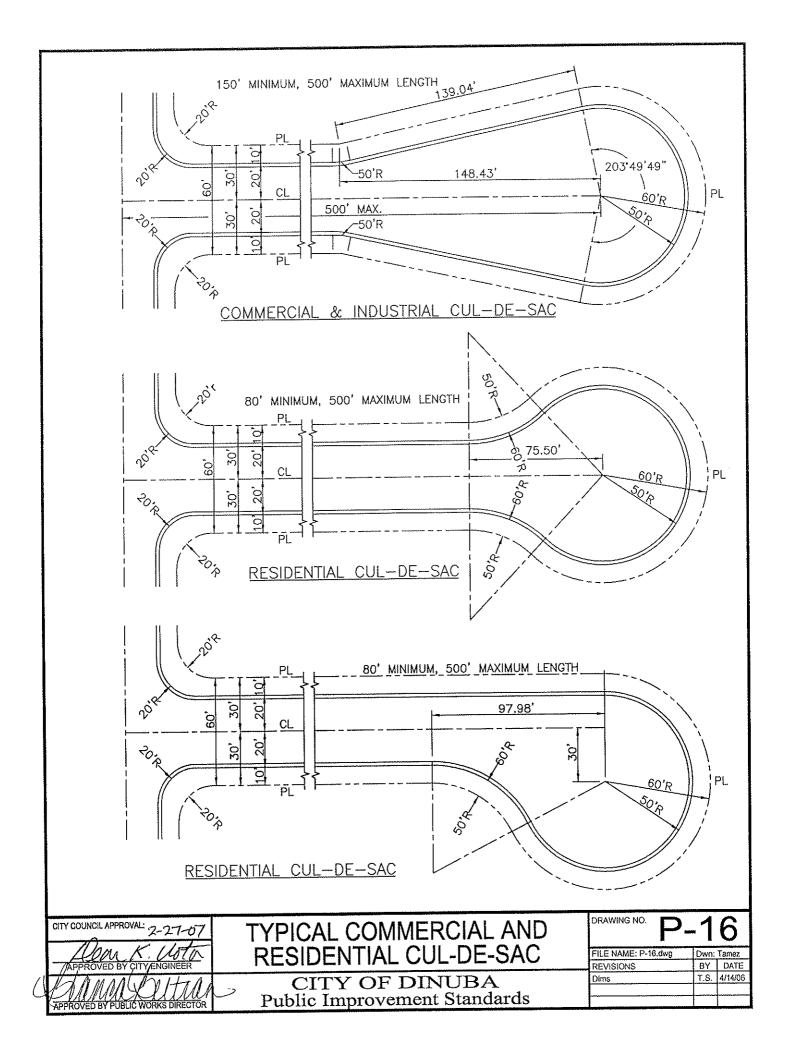

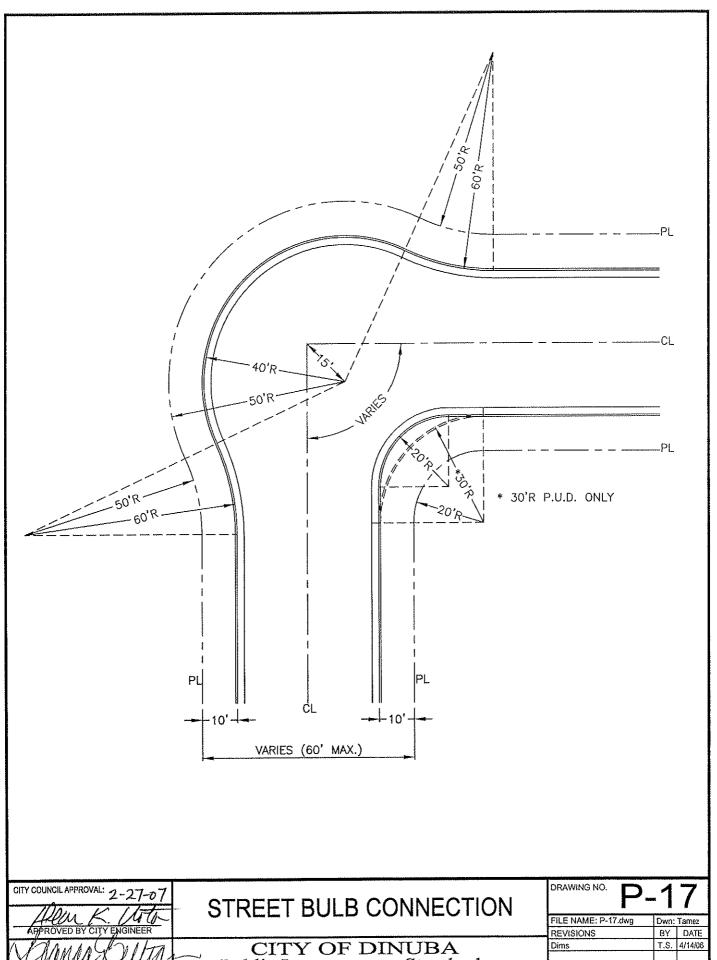


FILE NAME: P-17.dwg	Dwn:	Tamez
REVISIONS	BY	DATE
Dims	T.S.	4/14/06

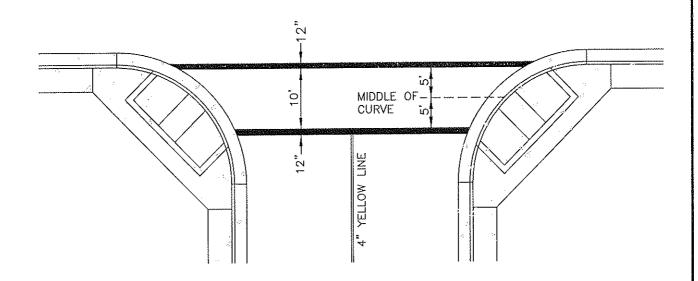

STANDARD CROSSWALK MARKING

- 1. SCHOOL CROSSWALK MARKINGS SHALL BE WITHIN 600' OF SCHOOLGROUNDS.
- 2. STRIPING SHALL BE LEGEND BUILT "THERMOPLASTIC" WITH REFLECTIVE GLASS BEADS.
- 3. SCHOOL CROSSWALKS TO BE YELLOW (OTHER PEDESTRIAN CROSSWALKS SHALL BE WHITE).
- 4. ALL PAVEMENT MARKINGS SHALL CONFORM TO CALTRANS STANDARDS.

	CITY COUNCIL APPROVAL: 2-27-07	STANDARD CROSSWALK	DRAWING NO. P.	-18	}
l	APPROVED BY CITY ENGINEER	MARKINGS	FILE NAME: P-18.dwg REVISIONS	Dwn: C.Tan	
1	DUNCO SULLIAN APPROVED BY PUBLIC WORKS DIRECTOR	CITY OF DINUBA Public Improvement Standards	Gen Notes, Dims	T.S. 4/14/	/06

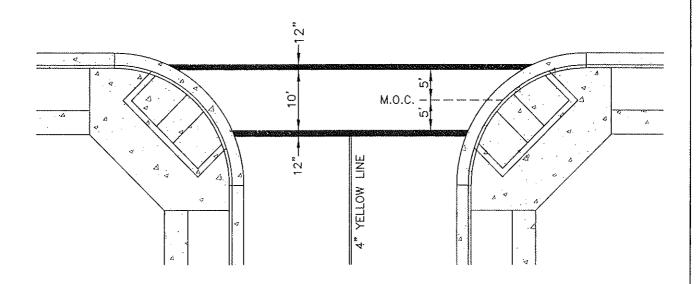

STANDARD CROSS-WALK MARKING

NOTES:


- SCHOOL CROSSWALK MARKINGS SHALL BE WITHIN 600' OF SCHOOLGROUNDS. STRIPING SHALL BE LEGEND BUILT PAINT "THERMOPLASTIC" WITH RETROFLECTIVE 2. GLASS BEADS. REFER TO 2007 GENERAL PLAN UPDATE.
- 3.

CITY COUNCIL APPROVAL: 2-27-07

STANDARD CROSSWALK MARKINGS WITH PARK STRIPS

CITY OF DINUBA Public Improvement Standards DRAWING NO. P-18a

FILE NAME: P-18a.dwg	Dwn:	C.Tamez
REVISIONS	BY	DATE
Gen Notes, Dims	T,S.	4/14/06
Park Strips	S.S.	12/18/06

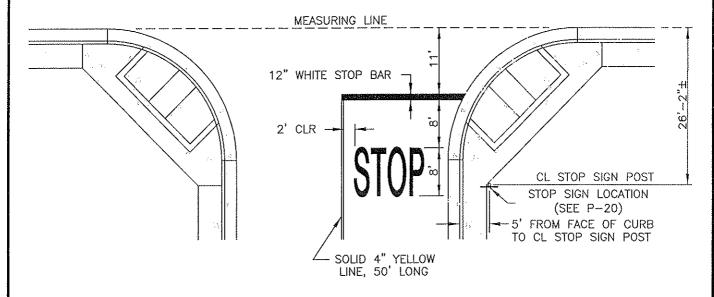


STANDARD STOP BAR MARKING

NOTES:

1. STRIPING/MARKINGS SHALL BE LEGEND BUILT "THERMOPLASTIC" WITH REFLECTIVE GLASS BEADS.

CITY COUNCIL APPROVAL: 2-27-07	STANDARD STOP BAR AND	DRAWING NO. P_	18b
APPROVED BY CITY ENGINEER	STOP SIGN LOCATION MARKINGS	FILE NAME: P-18b.dwg REVISIONS	Dwn; C.Tame
APPROVED BY PUBLIC WORKS DIRECTOR	CITY OF DINUBA Public Improvement Standards	Gen Notes, Dims	T.S. 4/14/06

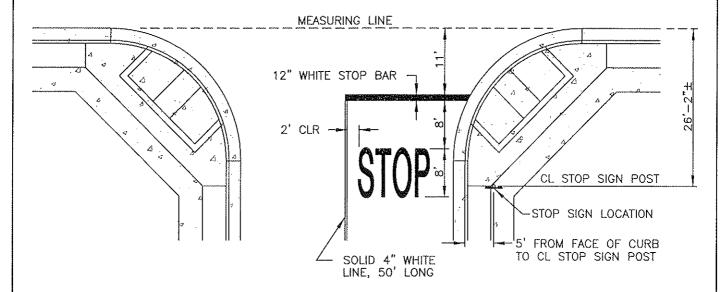

STANDARD STOP BAR MARKING

NOTES:

- STRIPING/MARKINGS SHALL BE LEGEND BUILT PAINT "THERMOPLASTIC" WITH RETROFLECTIVE GLASS BEADS.
- 2. REFER TO 2007 GENERAL PLAN UPDATE.

CITY COUNCIL APPROVAL: 2-27-07

APPROVED BY CITY ENGINEER

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STANDARD STOP BAR AND STOP SIGN LOCATION MARKINGS WITH PARK STRIPS

CITY OF DINUBA Public Improvement Standards P-18C
FILE NAME: P-18c.dwg Dwn: C.Tamez
REVISIONS BY DATE

FILE NAME: P-18c.dwg	Dwn:	C.Tamez
REVISIONS	BY	DATE
Gen Notes, Dims	T.S.	4/14/06
Park Strips	S.S.	12/18/06

INSTALLATION REQUIREMENTS AND MATERIALS

- ATTACH SIGNS, SLEEVE AND ANCHOR TO POST WITH MULTI-GRIP DRIVE RIVETS ("UNISTRUT" TL-3806 OR EQUAL.
- POST, ANCHOR, SLEEVE AND MOUNTING HARDWARE SHALL BE GALVANIZED "UNISTRUT" TELSPAR OR EQUAL WITH 7/16" HOLE ON 1" CENTERS ON ALL 4 SIDES.
- INSTALL SIGNS AND POSTS IN LOCATION APPROVED BY THE CITY.
- THE CITY.


 4. ALL SIGNS ARE TO COMPLY WITH CALTRANS STANDARDS, CONSTRUCTED OF .080 GUAGE ALUMINUM. STREET NAME SIGNS SHALL BE COVERED WITH 4" TYPE C HIGH INTENSITY SILVER LETTERS.
- 5. STREET SIGN HARDWARE: REFER TO TABLE BELOW.
- 6. SAWCUT REQUIRED IF SIGN INSTALLED AFTER SIDEWALK IS POURED.
- 7. STOP SIGNS SHALL HAVE HIGH INTENSITY PRIZMATIC SHEETING.
- 8. ALL SIGNS LOCATED IN SIDEWALK BY CITY APPROVAL
- 9. STREET NAME SIGN SHALL BE HIGH INTENSITY PRIZMATIC SIGNS.

STREET SIGN HARDWARE TABLE

MANUFACTURER	02.02	LENGTH RDWARE STYLE
ZUMAR	24"	30" or 36"
MANUFACTURING	606F	808F

APPROVED ABREVIATIONS

PLACEPL LANE BOULEVARDBLVD		CIRCLEC DRIVED ROADRI LANELN
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CITY COUNCIL APPROVAL: 2-27-07

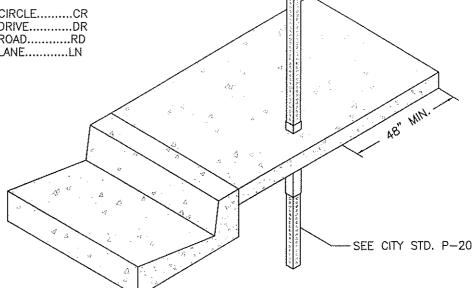PROVED BY PUBLIC WORKS DIRECTOR

STREET SIGN STANDARD

(Page 1 of 2)

CITY OF DINUBA Public Improvement Standards DRAWING NO. D_10

 FILE NAME: P-19.dwg
 Dwn: Tamez

 REVISIONS
 BY
 DATE

 Gen Notes
 T.S.
 4/14/06

INSTALLATION REQUIREMENTS AND MATERIALS

- ATTACH SIGNS, SLEEVE AND ANCHOR TO POST WITH MULTI-GRIP DRIVE RIVETS ("UNISTRUT" TL-3806 OR
- POST, ANCHOR, SLEEVE AND MOUNTING HARDWARE SHALL BE GALVANIZED "UNISTRUT" TELSPAR OR EQUAL WITH 7/16" HOLE ON 1" CENTERS ON ALL 4 SIDES.
- 3. INSTALL SIGNS AND POSTS IN LOCATION APPROVED BY THE CITY.
- 4. ALL SIGNS ARE TO COMPLY WITH CALTRANS STANDARDS. CONSTRUCTED OF .080 GUAGE ALUMINUM. STREET NAME SIGNS SHALL BE COVERED WITH 4" TYPE C HIGH INTENSITY SILVER LETTERS.
- 5. STREET SIGN HARDWARE: REFER TO TABLE BELOW.
- SAWCUT REQUIRED IF SIGN INSTALLED AFTER SIDEWALK IS POURED.
- STOP SIGNS SHALL HAVE HIGH INTENSITY PRIZMATIC 7. SHEETING.
- 8. STREET NAME SIGN SHALL BE HIGH INTENSITY PRIZMATIC SIGNS.
- REFER TO 2007 GENERAL PLAN UPDATE.



MANUFACTURER	BLADE LENGTH BLADE HARDWARE STYLE			
ZUMAR	24"	30" or 36"		
MANUFACTURING	606F	808F		

APPROVED ABREVIATIONS

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COURTCT	CIRCLECR							_	/
STREETST	DRIVEDR							4	
AVENUEAVE	ROADRD						· ·		*
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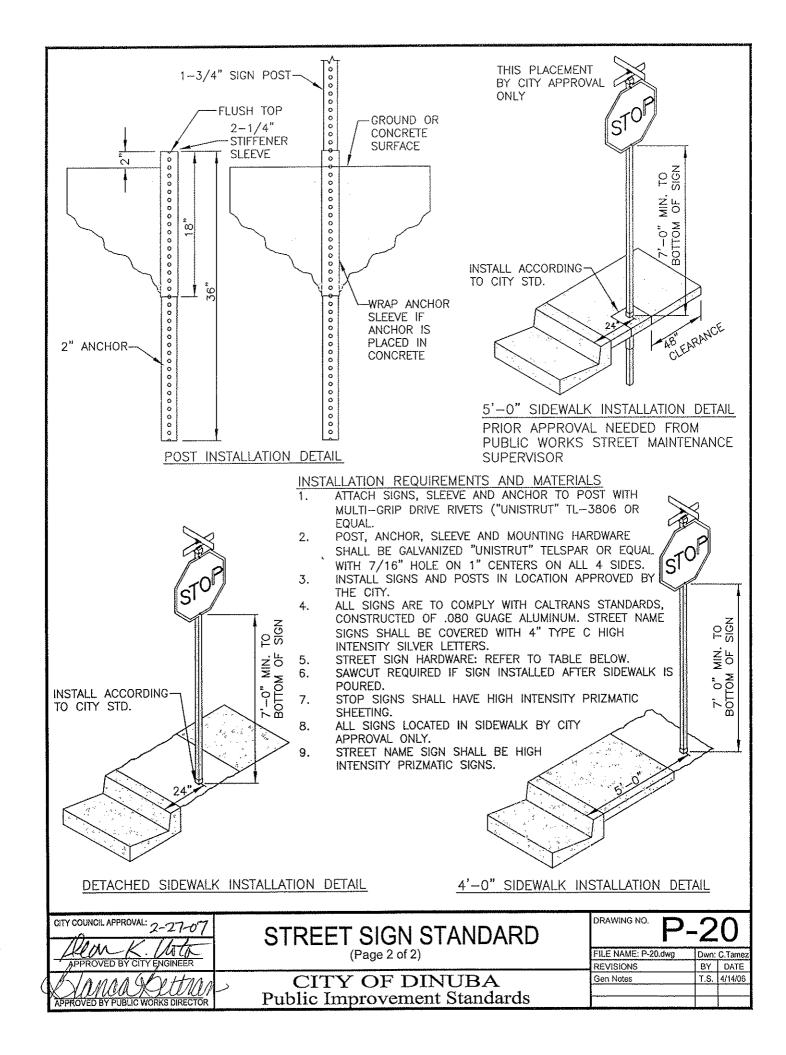
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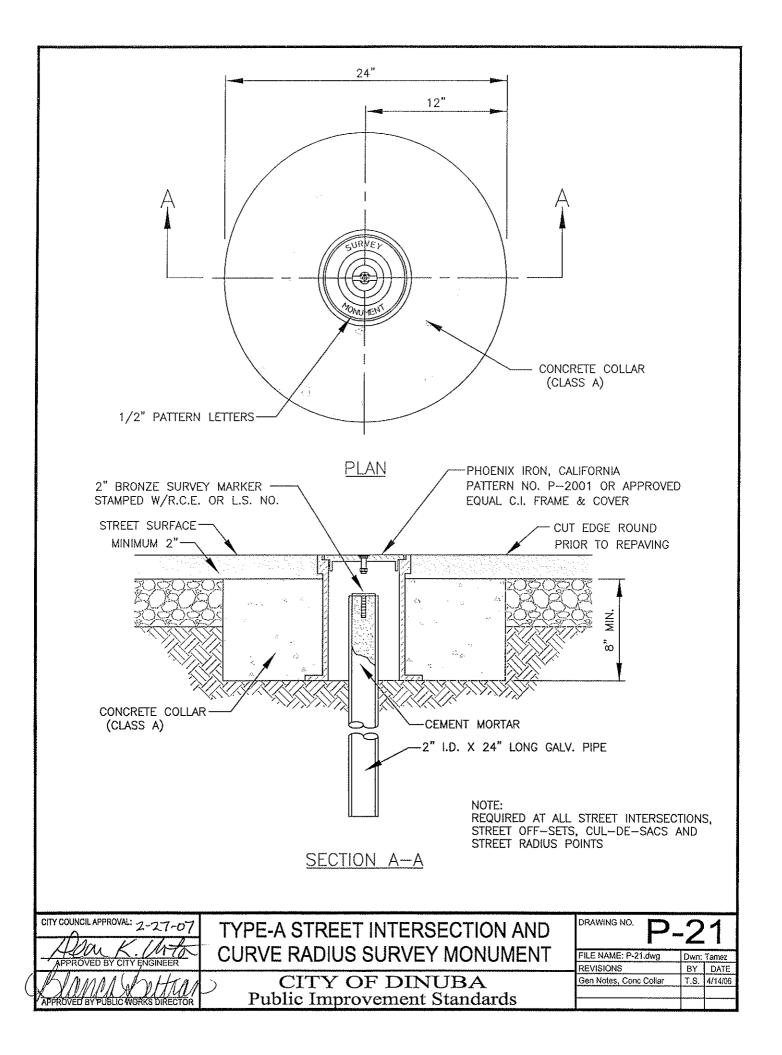
CITY COUNCIL APPROVAL:


STREET SIGN STANDARD WITH PARK STRIPS

CITY OF DINUBA Public Improvement Standards DRAWING NO.

FILE NAME: P-19a.dwg Dwn: Tamez BY DATE REVISIONS Gen Notes T.S. 4/14/06 Park Strips S.S. 12/18/06







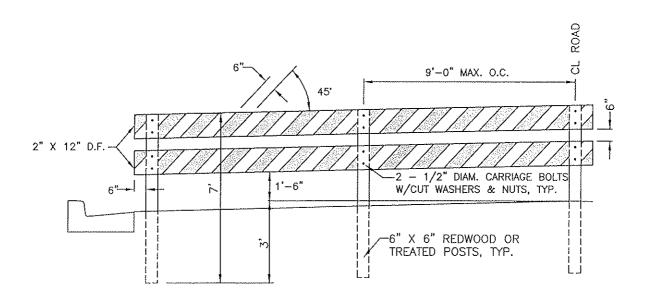


- 1. THE BARRICADE MUST EXTEND ACROSS THE FULL WIDTH OF PAVEMENT.
- 2. WOOD PRESSURE TREATED WITH A PRESERVATIVE MAY BE SUBSTITUTED FOR REDWOOD MATERIAL,
- 3. BARRICADES SHALL BE PAINTED WITH 2 COATS OF COMMERCIAL QUALITY WHITE BEAD ENAMEL. MARKINGS ON BARRICADE RAILS SHALL BE HIGH INTENSITY WITH ALTERNATE ORANGE AND WHITE STRIPES 6" IN WIDTH SLOPING DOWNWARD AT A 45' ANGLE. THE DOWNWARD SLOPE OF THE STRIPES DIRECTION TRAFFIC MUST TURN IN DETOURING. WHERE BOTH RIGHT AND LEFT TURNS ARE PROVIDED FOR, THE STRIPING MAY SLOPE DOWNWARD IN BOTH DIRECTIONS FROM THE CENTER OF THE BARRICADE. WARNING SIGNS MAY BE REQUIRED ON THE BARRICADE BY THE CITY ENGINEER.
- 4. BARRICADE POSTS SHALL BE PLACED AT THE EDGE OF A.C. PAVEMENT. THE PAVEMENT EDGE SHALL BE A STRAIGHT CLEAN EDGE.


	CITY COUNCIL APPROVAL: 2-27-07	TIMBER BARRICADE	DRAWING NO.	-22
١	APPROVED BY CITY ENGINEER		FILE NAME: P-22.dwg REVISIONS	Dwn: Tamez BY DATE
8	DAMAS HALLS APPROVED BY PUBLIC WORKS DIRECTOR	CITY OF DINUBA Public Improvement Standards	Gen Notes	T.S. 4/14/06

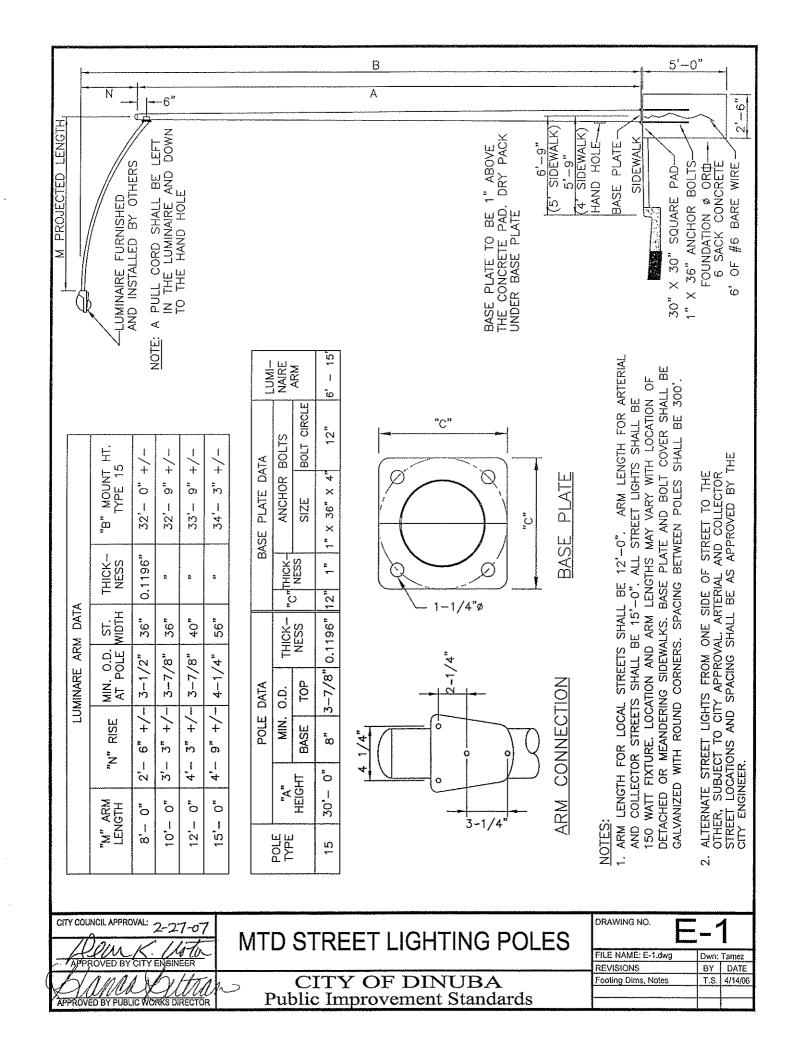


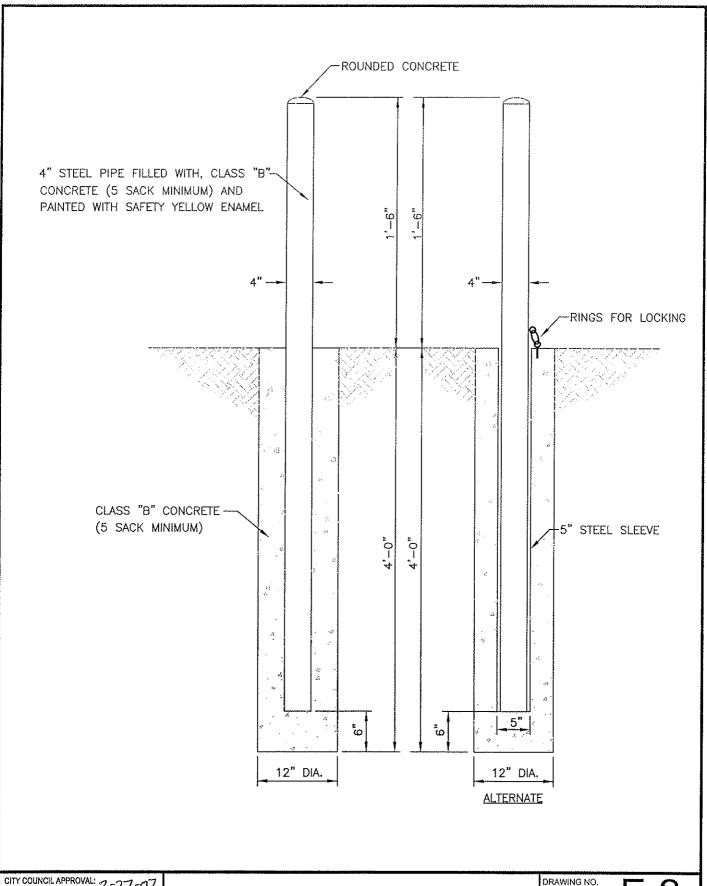

CITY COUNCIL APPROVAL: 2-27-07	PROTECTION POST	DRAWING NO.	E-2
APPROVED BY CITY ENGINEER		FILE NAME; E-2,dwg	Dwn: Tamez
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APPROVED BY PUBLIC WORKS DIRECTOR			

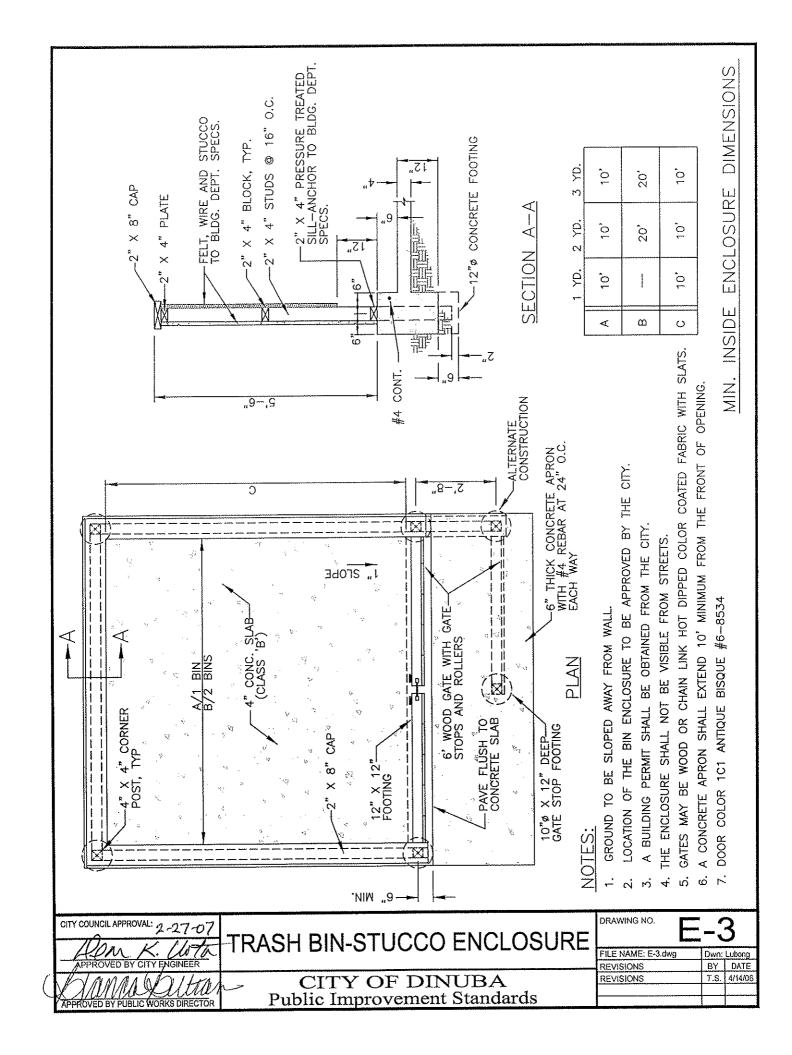


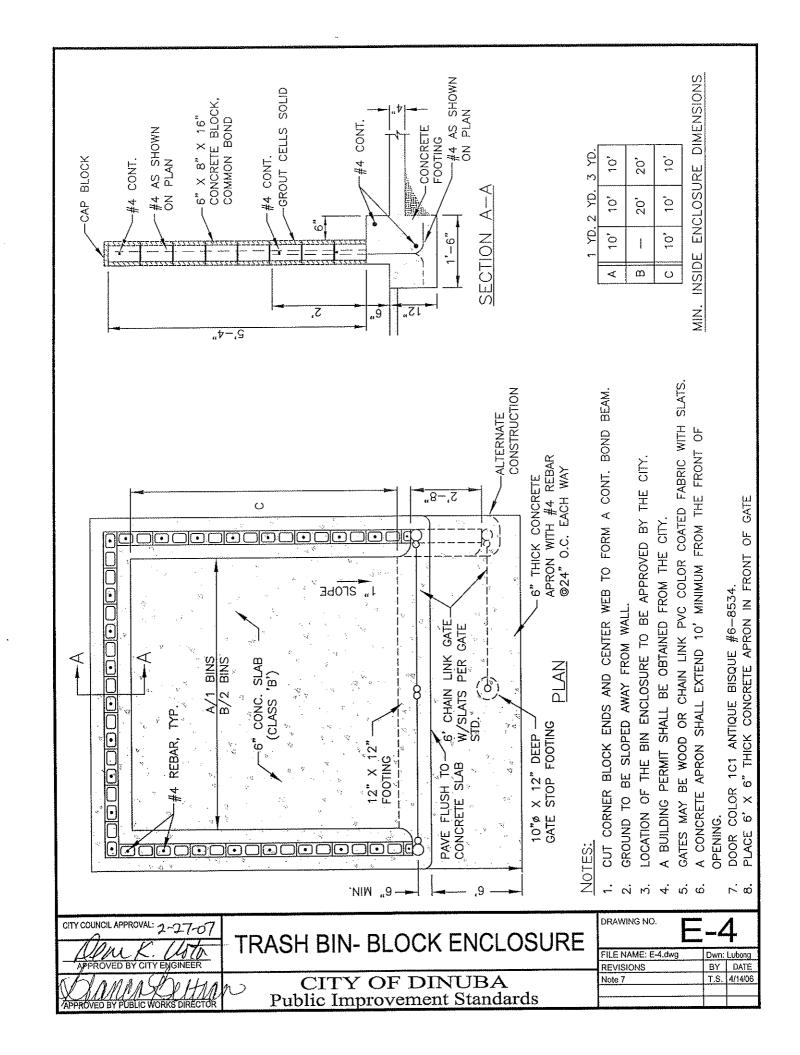


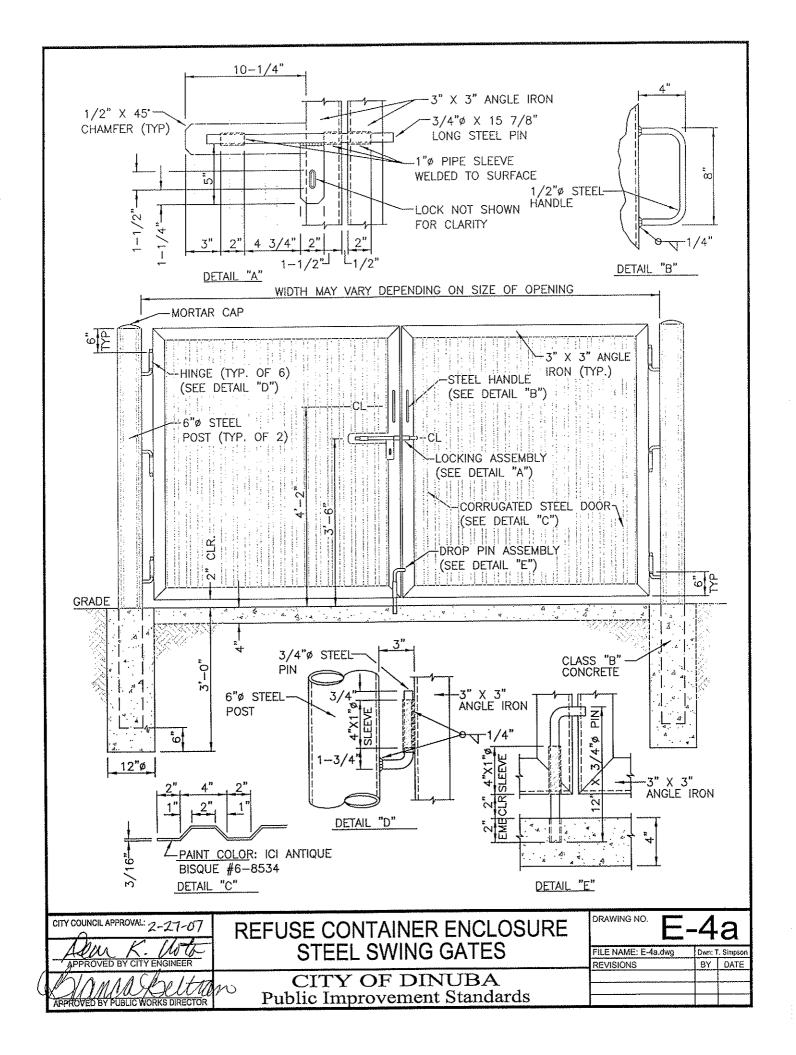

POST TOPS, EXTENSION ARMS, STRECHER BARS AND OTHER REQUIRED FITTINGS AND HARDWARE SHALL BE STEEL OR MALLEABLE IRON OR WROUGHT IRON AND SHALL BE GALVANIZED.

WIRE USED IN THE MANUFACTURE OF THE FABRIC SHALL BE 11-GAGE FOR ALL FENCE 84" OR LESS IN HEIGHT, AND SHALL BE WOVEN INTO APPROXIMATE 2" MESH, PVC COATED, AND COLOR SPECIFIED.

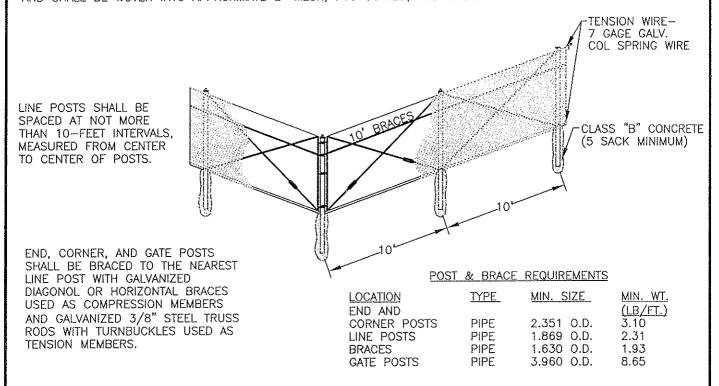

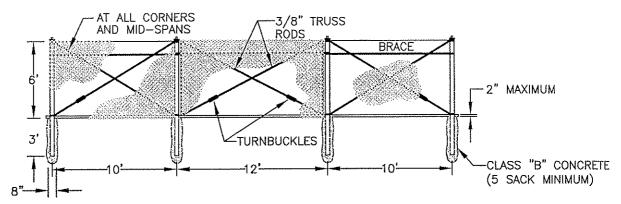

GATE FRAME SHALL BE CONSTRUCTED OF NOT LESS THAN 1-1/2" GALVANIZED PIPE AND SHALL BE CROSS TRUSSED WITH 3/8" ADJUSTABLE TRUSS RODS. THE CORNER OF GATE FRAMES SHALL BE FASTENED TOGETHER WITH A MALLEABLE IRON FITTING.


THE GATE SHALL BE HUNG BY AT LEAST 2 STEEL OR MALLEABLE IRON HINGES NOT LESS THAN 3" INCHES IN WIDTH, AND A MALLEABLE CATCH AND LOCKING ATTACHMENT.


ALL POSTS SHALL BE MINIMUM OF 9' LONG.


ALL FENCES SHALL HAVE REQUIRED SAFETY SIGNS INSTALLED TO CITY STANDARDS (EVERY 100').

CITY COUNCIL APPROVAL: 2-27-07	CHAIN LINK FENCE DETAIL	DRAWING NO.	Ξ-5
APPROVED BY CITY ENGINEER		FILE NAME: E-5.dwg REVISIONS	Dwn: Lubong BY DATE
APPROVED BY PUBLIC WORKS DIRECTOR	CITY OF DINUBA Public Improvement Standards	Border	T.S. 4/14/06



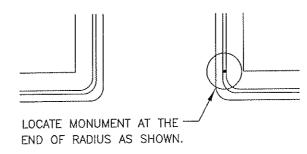

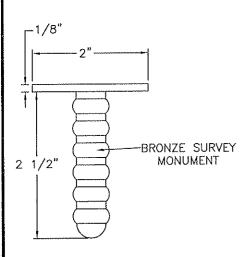


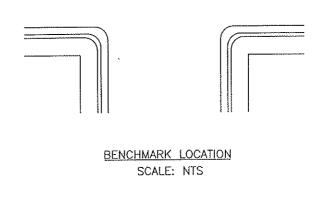

SURVEY MONUMENT

NOTES

- LOCATE BENCHMARKS AT THE NORTHEAST CORNER OF INTERSECTIONS APPROVED BY THE CITY.
- 2. COMPLETE NOTES SHOWING LOCATIONS, ELEVATIONS, AND CLOSURES SHALL BE FILED WITH THE CITY.
- 3. ELEVATIONS SHALL BE BASED ON DATUM USED ON U.S.C., G.S. AND CITY RECORD BENCHMARKS. 4. BENCHMARK NUMBER SHALL BE STAMPED WITH DIES ON TOP.

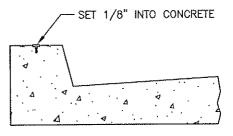

STANDARD CURB & GUTTER
SCALE: NTS

CITY COUNCIL APPROVAL: 2-27-07


APPROVED BY CITY EPIGINEER

DAWN HUMAN

ELEVATION BENCHMARK DETAILS


CITY OF DINUBA Public Improvement Standards

DRAWING NO.	E	-(3
FILE NAME: E-6.dwg		Dwn:	Lubong
REVISIONS		ΒY	DATE
Border		T.S.	4/14/06

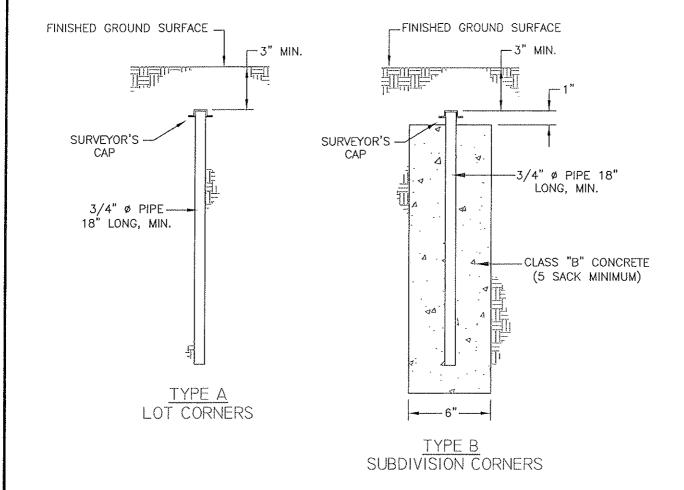

- STATE LAW REQUIRES ALL CORNERS TO BE TAGGED WITH SURVEYOR'S NUMBER.
 ALL SUBDIVISION LOT CORNERS SHALL REQUIRE TYPE A MONUMENTS.
 REGULAR SHAPED SUBDIVISIONS SHALL REQUIRE TYPE B MONUMENTS AT ALL CORNERS.
 IRREGULAR SHAPED SUBDIVISION SHALL HAVE ALL ANGLE AND CURVE POINTS MARKED
 WITH TYPE B MONUMENTS.

	CITY COUNCIL APPROVAL: 2-27-07	PROPERTY MONUMENT DETAILS	DRAWING NO.	- 7	7
	APPROVED BY CITY ENGINEER		FILE NAME: E-7.dwg REVISIONS	Dwn:	Lubong DATE
1	Stanga Detran	CITY OF DINUBA	Border	———	4/14/06
7	APPROVED BY PUBLIC WORKS DIRECTOR	Public Improvement Standards			

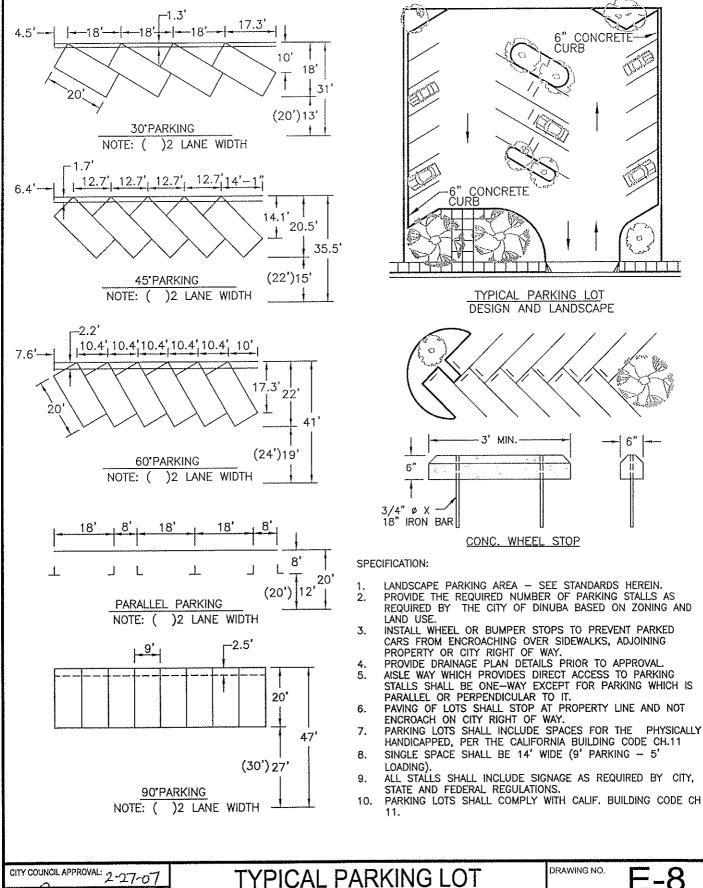

DESIGN AND LANDSCAPE


CITY OF DINUBA

Public Improvement Standards

DRAWING NO. FILE NAME: E-8.dwg Dwn: Lubong BY DATE REVISIONS T.S. 4/14/06 Border

6" CONCRETE CURB

o

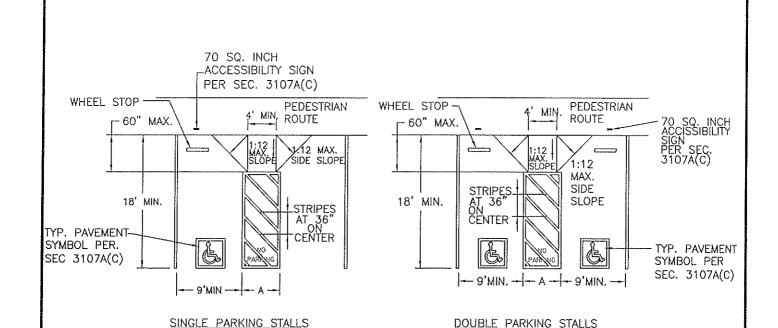

MIN. 48" PEDESTRIAN 70 SQ. INCH-ROUTE ACCESSIBILITY SIGN PER SEC. 3107A(C) WHEEL STOP FACE OF CURB STRIPES AT 36" ON CENTER 1:12 MAX. SIDE SLOPE 18' MIN STALL DEPTH TYP. PAVEMENT 9' MIN. SYMBOL PER STALL WIDTH SEC. 3107A(C)

NOTE:
A.=5' MIN. AT TYPICAL PARKING STALL, 8' MIN. AT VAN ACCESSIBLE PARKING STALL.

DIAGONAL PARKING STALLS

CITY COUNCIL APPROVAL: 2-27-07

ADMINISTRATION HANDICAPPED PARKING


PPROVED BY CITY ENGINEER

CITY OF DINUBA
PROVED BY PUBLIC WORKS DIRECTOR

CITY OF DINUBA
Public Improvement Standards

DRAWING NO. E-9

FILE NAME: E-9.dwg Dwn: Lubong
REVISIONS BY DATE
Border T.S. 4/14/06

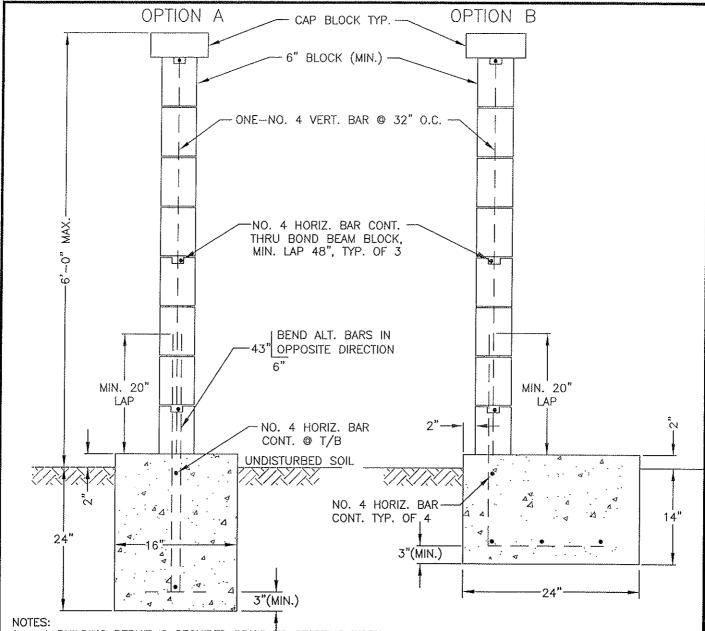


A BUILDING PERMIT IS REQUIRED PRIOR TO STARTING WORK


- PROP CORNERS SHALL BE LOCATED AND A STRING LINE PLACED ON THE STAKES TO IDENTIFY PROP LINE AT 2. FTG INSPECTION
- CONCRETE STRENGTH MIN 2,500 PSI \otimes 28 DAYS, MIN 5 SACK CONCRETE. REINFORCED STEEL ASTM A615, MIN FS = 18,000 PSI MIN GRADE 40.
- 4.
- 5.
- CONCRETE MASONRY UNITS (6" MIN.)— ASTM C90; CONCRETE BLOCKS GRADE 'A'.

 GROUT 1 PART CEMENT, 2 TO 3 PARTS SAND, 2 PARTS PEA GRAVEL, 2,000 PSI @ 28 DAYS. ALL BLOCK CELLS SHALL BE GROUTED, ALL GROUT SHALL BE VIBRATED BY AN APPROVED METHOD.

 MORTAR SHALL COMPLY WITH UBC CHAPTER 21. STRENGTH = 1,800 PSI @ 28 DAYS.

 SOILS MAX. ALLOWABLE SOIL BEARING PRESSURE = 2,000 PSF.
- 8.
- 9. BACKFILL - COHESIONLESS SOIL.
- ALL BLOCK FENCES OVER 6' OR FOR A DEVELOP PROJ. REQUIRES AN APPROVAL BY THE DEVELOPMENT REVIEW COMMITTEE.
- ALL BLOCK FENCES OVER 6' ARE REQUIRED TO BE STAMPED AND SIGNED BY A LICENSED CIVIL ENGINEER. 11. PROVIDE PLANS, DETAILS AND CALCULATIONS.
- ALL BLOCK WALLS FOR SUBDIVISION DEVELOPMENTS SHALL BE SPLIT FACE BLOCKS & COLOR TO BE APPROVED
- BLOCK WALL/FENCE CALCULATIONS SHALL BE SUBMITTED TO THE CITY OF DINUBA BY A CA REGISTERED ENGINEER.

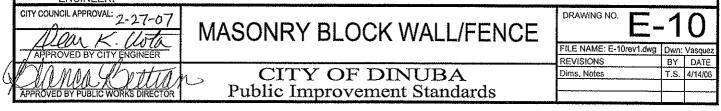

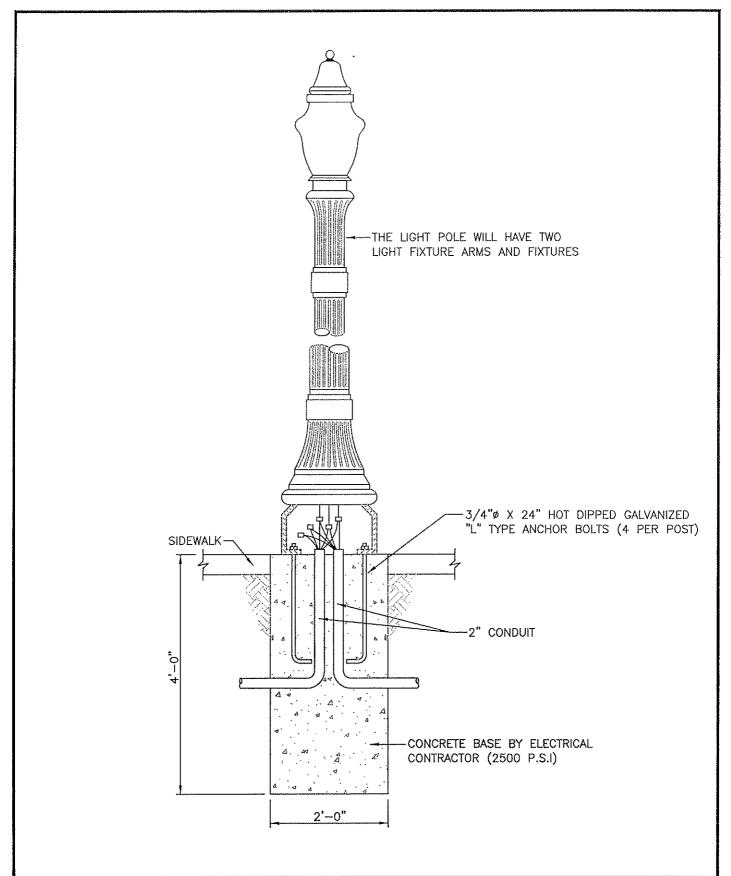

"ANAHEIM" STREET & AREA LIGHT

POLE BASE DETAIL

CITY OF DINUBA


Proved by Public Works Director

CITY OF DINUBA


Public Improvement Standards


DRAWING NO. E-11

FILE NAME: E-11.dwg Dwn: Simpson REVISIONS BY DATE

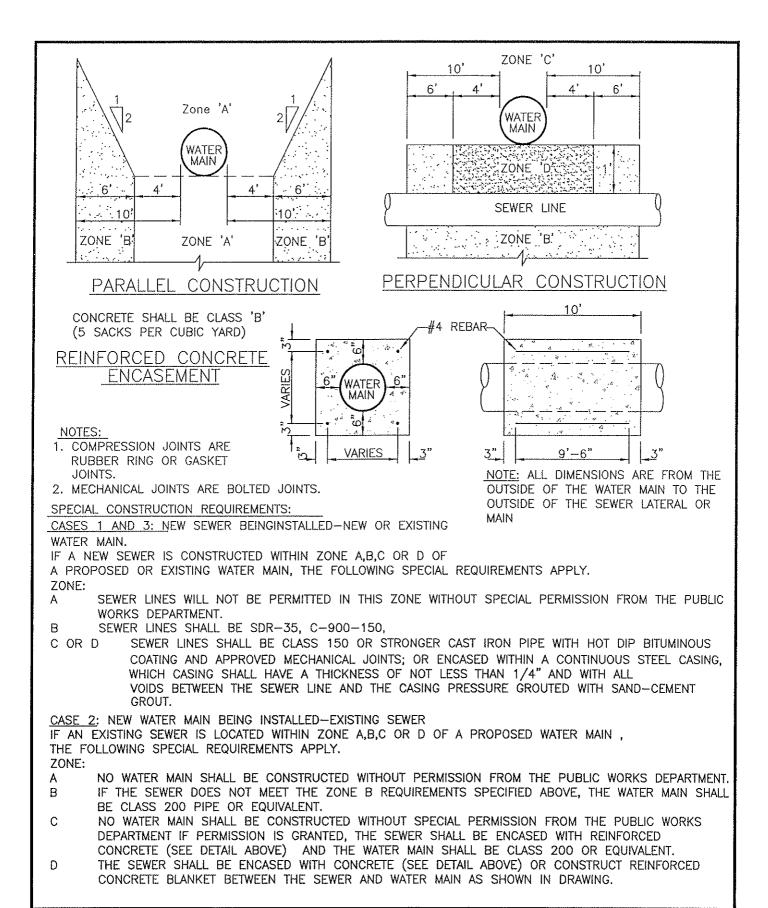

CITY COUNCIL APPROVAL: 2-27-07	SPECIAL CONST. REQUIREMENTS	DRAWING NO.	_1	2
APPROVED BY CITY ENGINEER	FOR SEWER & WATER SEPARATION	FILE NAME: E-12.dwg REVISIONS	Dwn: T.	Simpson DATE
APPROVED BY PUBLIC WORKS DIRECTOR	CITY OF DINUBA Public Improvement Standards	1127010110		DATE

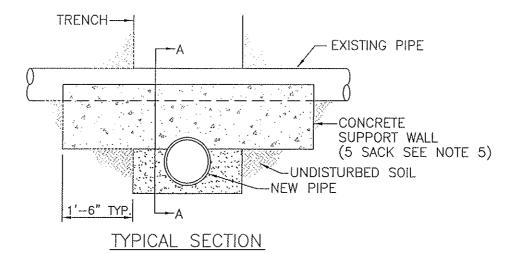

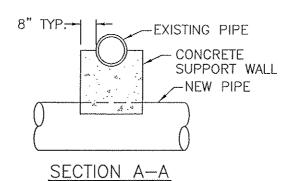


- 1. THE SUPPORTING WALL SHALL HAVE A FIRM BEARING ON THE SUBGRADE AND AGAINST THE SIDES OF THE EXCAVATION.
- 2. THE WALL SHALL BE AT LEAST 6" FREE AND CLEAR OF WATER MAINS OR OTHER CONDUITS OR DUCTS.

 3. THE WALL THICKNESS SHALL BE EQUAL TO THE O.D. OF THE PIPE +8".

 4. THE EXISTING PIPE SHALL BE ENCASED TO THE SPRINGLINE.


- 5. AN ALTERNATIVE MAY BE A 2 SACK MIN. SLURRY DESIGN MIX.
- 6. VERIFY WITH UTILITY COMPANIES FOR CLEARANCE.

СП	y council approval: 2-27-07 Llow K. Usta	ACROSS TRENCHES		-13
	APPROVED BY CITY ENGINEER	MONOGO TINENGTIEG	FILE NAME: E-13.dwg REVISIONS	BY DATE
AP	YAMUS SULLAND PROVED BY PUBLIC WORKS DIRECTOR	CITY OF DINUBA Public Improvement Standards		J. Jane

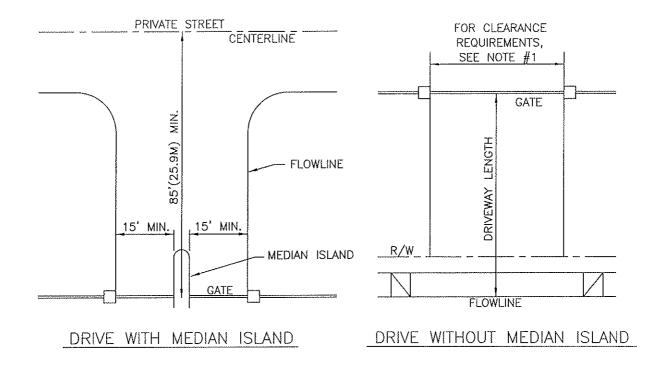


- 1. SLIDING OR SWINGING GATES SHALL PROVIDE A MINIMUM HORIZONTAL CLEARANCE OF 15' FOR A ONE WAY DRIVE WITH A MEDIAN ISLAND, 20' FOR A ONE WAY DRIVE WITHOUT A MEDIAN ISLAND, OR 24' FOR A TWO WAY APPROACH. ALL GATES MUST HAVE A MINIMUM VERTICAL OF 14' WHEN GATE IS IN THE FULL OPEN POSITION. HORIZONTAL DISTANCE SHALL BE MEASURED PERPENDICULAR TO THE DIRECTION OF TRAVEL ON THE DRIVEWAY. VERTICAL DISTANCE SHALL BE MEASURED FROM THE HIGHEST ELEVATION OF THE DRIVEWAY TO THE LOWEST OVERHEAD OBSTRUCTION.
- 2. A FIREBOX ENCLOSURE WITH AN OVERRIDE SWITCH TO OPEN THE GATE SHALL BE INSTALLED AT EACH GATE LOCATION. THE FIREBOX SHALL BE INSTALLED ON THE GATE CONTROL PEDESTAL OR ON THE GATE CONTROL BOX. THE FIREBOX SHALL BE A N.E.M.A. TYPE 3R RAIN TIGHT CABINET WITH A STANDARD KEY LOCK. STANDARD KEY LOCK. STANDARD KEY LOCK SHALL BE APPROVED BY THE CITY OF DINUBA FIRE DEPARTMENT PRIOR TO INSTALLATION THE OVERRIDE SWITCH SHALL BE MOUNTED ON A DEADFRONT SWITCH—BOARD. CONTACT FIRE MARSHALL FOR ADDITIONAL INFORMATION.
- 3. ALL ELECTRICAL EQUIPMENT FOR USE IN A FIREBOX SHALL CONFORM TO SECTION 86-1.02 "REGULATIONS AND CODE OF THE STANDARD SPECIFICATIONS, STATE OF CALIFORNIA, DEPARTMENT OF TRANSPORTATION", APPROVED CURRENT EDITION.
- 4. THE GATE OPERATOR SHALL HAVE A DISCONNECT FEATURE FOR MANUAL OPERATIONS OF THE GATE WHEN POWER FAILS.
- 5. MINIMUM DRIVEWAY LENGTH FROM THE GATE TO THE FLOWLINE OF A PUBLIC STREET SHALL BE 50' OR AS PER TABLE 6.9.2. OF THE SUBDIVISION DESIGN MANUAL, WHICHEVER IS GREATER. MULTIPLE LANES IN A DRIVEWAY MAY BE CONSIDERED IN REDUCING REQUIRED DRIVEWAY LENGTH, BUT IN NO CASE WILL THE MINIMUM LENGTH BE LESS THAN 50'.
- 6. MINIMUM ROADWAY LENGTH FROM THE GATE TO THE CENTERLINE OF THE NEAREST PERPENDICULAR PRIVATE STREET SHALL BE 85' OR GREATER DUE TO THE TURNING RADIUS REQUIREMENTS OF CERTAIN TYPES OF FIRE EQUIPMENT.
- 7. PRIOR TO CONSTRUCTION, APPROVAL OF ALL PRIVATE GATES AND ACCESS MUST BE OBTAINED FROM THE CITY OF DINUBA FIRE DEPARTMENT.

CITY COUNCIL APPROVAL: 2-27-07	GATED ENTRY FOR		-1	4
APPROVED BY CITY ENGINEER	PRIVATE STREETS	FILE NAME: E-14,dwg REVISIONS	Dwn:	Simpson DATE
APPROVED BY PUBLIC WORKS DIRECTO	CITY OF DINUBA Public Improvement Standards			

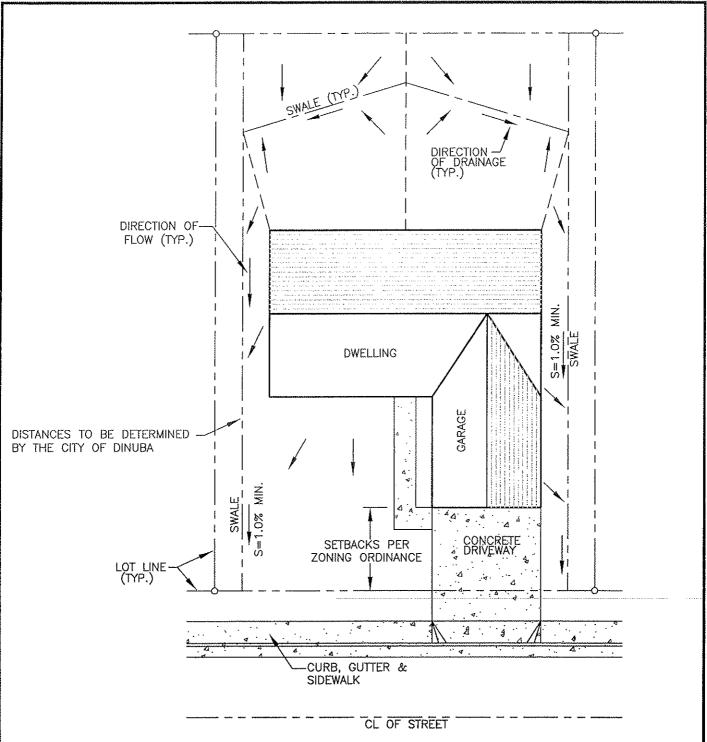


- LOTS SHALL BE GRADED TO DRAIN TO THE STREETS. 1.
- FINISH FLOOR ELEVATION SHALL BE A MIN. OF 18" FROM FLOWLINE OF CURB AT LOWEST POINT ALONG 2. PROP. FRONTAGE.
- 3.
- MAINTAIN POSITIVE DRAINAGE AWAY FROM DWELLING STRUCTURE, MINIMUM 5' AT 2%. A RETAINING STRUCTURE SHALL BE REQUIRED ALONG ALL SIDE AND BACKYARD PROPERTY LINES WHERE 4. GRADE DIFFERENTIAL EXCEEDS 6", UNLESS APPROVED OTHERWISE BY THE CITY ENGINEER. LANDSCAPING SHALL NOT ALTER LOT DRAINAGE DESIGN.
- 5.


CITY COUNCIL APPROVAL: 2-27-07 APPROVED BY CITY ENGINEER	TYPICAL LOT DRAINAGE	PILE NAME: E-15.dwg	-15 Dwn: Lubong BY DATE
APPROVED BY PUBLIC WORKS DIRECTOR	CITY OF DINUBA Public Improvement Standards	Gen Notes	T.S. 4/14/06

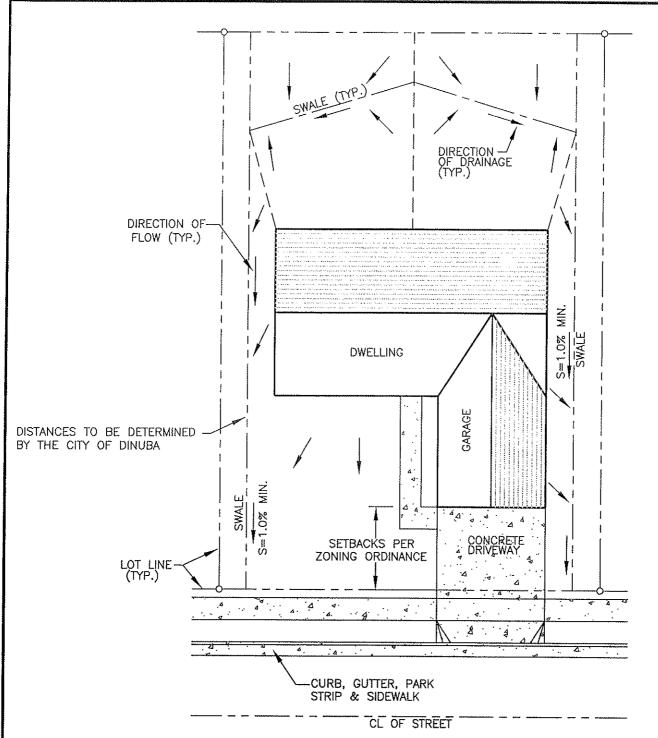

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- REFER TO 2007 GENERAL PLAN UPDATE.

CITY COUNCIL APPROVAL: TYPICAL LOT DRAINAGE DRAWING NO. WITH PARK STRIPS SHOWN FILE NAME: E-15a.dwg Dwn: Lubong BY DATE REVISIONS CITY OF DINUBA Gen Notes T.S. 4/14/06 Park Strips Public Improvement Standards S.S. 12/18/06

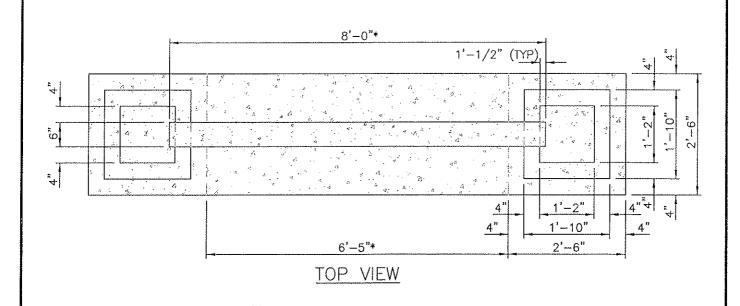

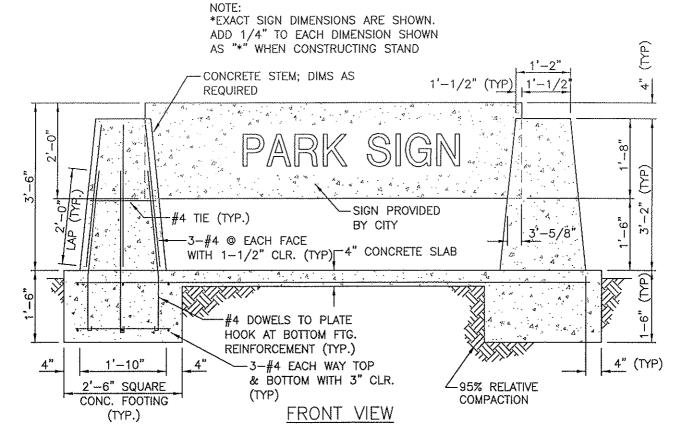

- 1. CONCRETE 5.5 SACK MINIMUM.
- 2. CONCRETE FINISH- FINE BROOM.
 - REBAR GRADE 60.

CITY COUNCIL APPROVAL: 2-27-07	MONUMENT SIGN	DRAWING NO. E-16		
APPROVED BY CITY ENGINEER	INIONOIVILINI SIGIN	FILE NAME: E-16.dwg REVISIONS	Dwn: T. Simpson BY DATE	
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